


TAX MAP

SCALE: 1" = 300'

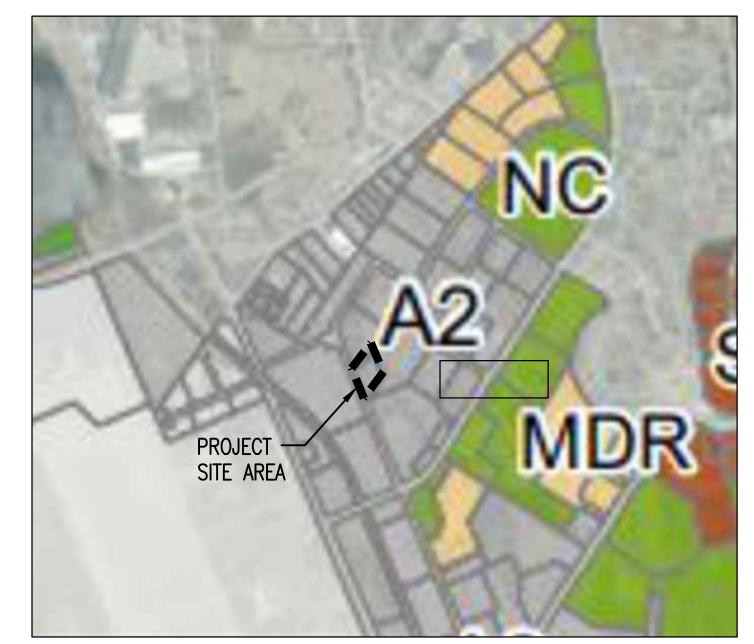

SURROUNDING ZONING DISTRICT MAP

SCALE: 1" = 1,000'

SYMBOL LEGEND

CONIFEROUS TREE


<u>SAMBOT</u>	<u>LEGEND</u>		
PROPOSED FEATURES		EXISTING FEATURES	
•	BOUND	•	BOUND
*	BENCHMARK	•	BENCHMARK
•	DRILL HOLE	•	DRILL HOLE
&	SURVEY POINT		SURVEY POINT
•	IRON PIN	•	IRON PIN
TP1 ■	TEST PIT	<i>TP1</i> ■■	TEST PIT
B1 ⊕	BORING	<i>B1</i> ⊕	BORING
P1 ○	PERC TEST		PERC TEST
	CATCH BASIN (SQUARE)		CATCH BASIN (SQUARE)
•	CATCH BASIN (ROUND)		CATCH BASIN (ROUND)
\Leftrightarrow	HEADWALL	\Leftrightarrow	HEADWALL
Δ	FLARED END SECTION	\triangle	FLARED END SECTION
	STONE APRON		STONE APRON
①	DRAIN MANHOLE (DMH)	(D)	DRAIN MANHOLE (DMH)
o c/0	DRAINAGE CLEAN OUT	o C/0	DRAINAGE CLEAN OUT
③	SANITARY SEWER MANHOLE (SMH)	\bigcirc	SANITARY SEWER MANHOLE (SMH)
O C/0	SANITARY CLEAN OUT	o C/0	SANITARY CLEAN OUT
\rightarrow	HYDRANT	750	HYDRANT
₩ W	WATER SHUTOFF	wv WV	WATER SHUTOFF
X 30 8 X 8 X	TAPPING SLEEVE & VALVE	S C WV WV GV	TAPPING SLEEVE & VALVE
\bowtie	GATE VALVE	\bowtie	GATE VALVE
W	WELL	W	WELL
ල	UTILITY POLE	0	UTILITY POLE
-•	GUY POLE	-•	GUY POLE
®	ELECTRICAL MANHOLE	E	ELECTRICAL MANHOLE
€	FLOOD LIGHT	€	FLOOD LIGHT
•=	LIGHT POST	\$	LIGHT POST
①	TELEPHONE MANHOLE	1	TELEPHONE MANHOLE
©	NATURAL GAS MANHOLE	(G)	NATURAL GAS MANHOLE
©	COMMUNICATION MANHOLE	©	COMMUNICATION MANHOLE
•	BOLLARD		BOLLARD
	SINGLE POLE SIGN	-0-	SINGLE POLE SIGN
- o- o-	DOUBLE POLE SIGN		DOUBLE POLE SIGN
+100.5	SPOT ELEVATION	+ 100.00	SPOT ELEVATION
Ġ	ACCESSIBLE PARKING STALL	Ġ.	ACCESSIBLE PARKING STALL
$\stackrel{\sim}{\Rightarrow}$	DRAINAGE FLOW	\Longrightarrow	DRAINAGE FLOW
$\bigcirc \bigcirc \bigcirc \bigcirc$	DECIDUOUS TREE		DECIDUOUS TREE
my on		1111/1/ = \$660	

NRCS SOIL CLASSIFICATION

LINETYPE LEGEND

PROPOSED FEATURES		EXISTING FEATURES	
100	- MAJOR CONTOUR		MAJOR CONTOUR
98 —	- MINOR CONTOUR	<i>98</i>	MINOR CONTOUR
	PROPERTY LINE		PROPERTY LINE
	- SETBACK		SETBACK
	- EASEMENT	<u> </u>	EASEMENT
	- CENTERLINE		CENTERLINE
	- EDGE OF PAVEMENT		EDGE OF PAVEMENT
	- EDGE OF GRAVEL		EDGE OF GRAVEL
	- EDGE OF CONCRETE		EDGE OF CONCRETE
	- CURB		CURB
x x	FENCE (BARBED WIRE)	X X	FENCE (BARBED WIRE)
o	FENCE (CHAIN LINK)	o o	FENCE (CHAIN LINK)
	- FENCE (WOODEN)		FENCE (WOODEN)
 	。GUARD RAIL	. 0 0 0 0 0 0	GUARD RAIL
	TREE LINE		TREE LINE
***************************************	. STONE WALL		STONE WALL
s	- SANITARY SEWER	s	SANITARY SEWER
		———(S)	SANITARY SEWER APPROX
FM	- SEWER FORCEMAIN	FM	SEWER FORCEMAIN
SD	- STORM LINE	SD	STORM LINE
		(SD)	STORM LINE APPROX.
UD	- UNDER DRAIN	UD	UNDER DRAIN
FD	- FOUNDATION DRAIN	FD	FOUNDATION DRAIN
RD	ROOF DRAIN	RD	ROOF DRAIN
- · · → · · → · · -	DITCH/SWALE		DITCH/SWALE
UGT	- UNDERGROUND TELECOMM	UGT	UNDERGROUND TELECOM
OHT	- OVERHEAD TELECOMM	OHT	OVERHEAD TELECOMM
UGE-	- UNDERGROUND ELECTRIC	UGE	UNDERGROUND ELECTRIC
OUE	- OVERHEAD ELECTRIC	OHE	OVERHEAD ELECTRIC
——————————————————————————————————————			
	- 6" WATER LINE		WATER LINE

__ _ _ NRCS SOIL BOUNDARY

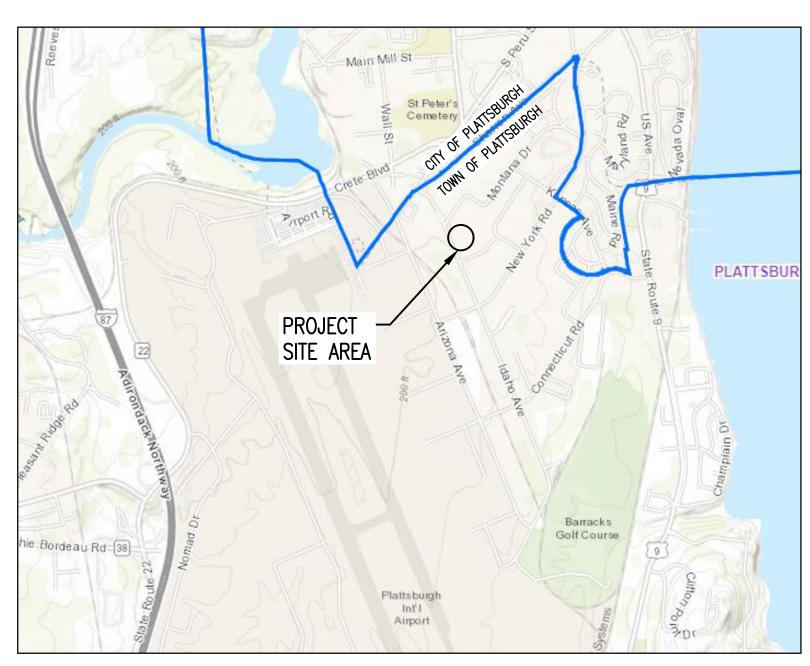

VICINITY MAP

SCALE: 1" = 2,000'

GENERAL NOTES

- 1. EXACT OBJECT LOCATIONS MAY DIFFER FROM THAT AS SHOWN, AND ADDITIONAL SUB-SURFACE AND SURFACE UTILITIES AND STRUCTURES MAY EXIST. THE CONTRACTOR IS TO PROCEED WITH GREAT CARE IN EXECUTING ANY WORK,
- 2. UTILITIES SHOWN DO NOT PURPORT TO CONSTITUTE OR REPRESENT ALL UTILITIES LOCATED UPON OR ADJACENT TO THE SURVEYED PREMISES. EXITING UTILITY LOCATIONS ARE APPROXIMATE ONLY. THE CONTRACTOR SHALL FIELD VERIFY ALL UTILITIES. ALL DISCREPANCIES SHALL BE REPORTED TO THE OWNER AND ENGINEER. SITE CONTRACTOR SHALL CALL UTILITY LOCATOR SERVICE AND UTILITY OWNERS 72 HOURS, EXCLUSIVE OF WEEKENDS AND HOLIDAYS, PRIOR TO ANY DIGGING, DRILLING, OR BLASTING:
- A. DIG SAFE (TEL: #811)

 B. NON DIG SAFE MEMBER FACILITY OPERATORS IF KNOWN. (A LIST OF DIG SAFE MEMBERS BY STATE CAN BE FOUND ON THE DIG SAFE WEB SITE WWW.DIGSAFE.COM)
- C. TOWN OF PLATTSBURGH WATER & WASTEWATER DEPARTMENT (518-563-8396)
- 3. THE ENGINEER SHALL BE NOTIFIED IN WRITING OF ANY CONDITIONS THAT VARY FROM THOSE SHOWN ON THE PLANS. THE CONTRACTOR'S WORK SHALL NOT VARY FROM THE PLANS WITHOUT THE EXPRESSED APPROVAL FROM THE ENGINEER.
- 4. THE CONTRACTOR IS INSTRUCTED TO COOPERATE WITH ANY AND ALL OTHER CONTRACTORS PERFORMING WORK ON THIS JOB SITE DURING THE PERFORMANCE OF THIS CONTRACT.
- 5. THE CONTRACTOR SHALL RESTORE LAWNS, DRIVEWAYS, CULVERTS, SIGNS AND OTHER PUBLIC OR PRIVATE PROPERTY DAMAGED OR REMOVED TO EXISTING CONDITIONS OR BETTER AS DETERMINED BY THE ENGINEER. ANY DAMAGED TREES, SHRUBS AND/OR HEDGES SHALL BE REPLACED AT THE CONTRACTOR'S EXPENSE, UNLESS NOTED OTHERWISE.
- 6. THE CONTRACTOR SHALL COMPLY WITH ALL REQUIRED PERMITS.
- 7. THE OWNER SHALL BE RESPONSIBLE FOR OBTAINING ALL BUILDING PERMITS. THE CONTRACTORS SHALL BE RESPONSIBLE FOR ALL WORK PERMITS, INSPECTIONS, AND CERTIFICATES.
- 8. THE CONTRACTOR WILL PROTECT EXISTING PROPERTY LINE MONUMENTATION. ANY MONUMENTATION DISTURBED OR DESTROYED, AS JUDGED BY THE ENGINEER OR OWNER SHALL BE REPLACED AT THE CONTRACTOR'S EXPENSE UNDER THE SUPERVISION OF A NEW YORK STATE LICENSED LAND SURVEYOR.
- 9. IT IS THE CONTRACTOR'S RESPONSIBILITY TO EXAMINE ALL PLAN SHEETS AND SPECIFICATIONS, AND COORDINATE WORK WITH ALL CONTRACTS FOR THE SITE.
- 10. IT IS THE CONTRACTOR'S RESPONSIBILITY TO CONDUCT EXPLORATORY TEST PITS AS MAY BE REQUIRED TO DETERMINE UNDERGROUND CONDITIONS.
- 11. ALL TRENCH EXCAVATION AND ANY REQUIRED SHEETING AND SHORING SHALL BE DONE IN ACCORDANCE WITH THE LATEST OSHA REGULATIONS FOR CONSTRUCTION.
- 12. CONTRACTOR SHALL BE RESPONSIBLE FOR DEWATERING AND THE MAINTENANCE OF SURFACE DRAINAGE DURING THE COURSE OF WORK. DEWATERING METHOD MUST BE APPROVED BY THE OWNER AND COORDINATED WITH THE TOWN OF PLATTSBURGH DEPARTMENT OF PUBLIC WORKS.
- 13. MAINTAIN FLOW FOR ALL EXISTING UTILITIES, UNLESS NOTED OTHERWISE.
- 14. CONTRACTOR TO GRADE ALL AREAS ON THE SITE TO PROVIDE POSITIVE DRAINAGE AWAY FROM BUILDINGS AND IMPERVIOUS SURFACES.
- 15. THE CONTRACTOR SHALL BE RESPONSIBLE FOR PROVIDING ALL FIELD LAYOUT. THE CONTRACTOR SHALL PROVIDE MARKED—UP AS—BUILT PLANS FOR ALL UTILITIES SHOWING CONNECTIONS, BENDS, VALVES, LENGTHS OF LINES AND INVERTS. AS—BUILT PLANS SHALL BE REVIEWED BY THE OWNER AND HIS REPRESENTATIVES BEFORE UTILITIES WILL BE ACCEPTED.
- 16. CONTRACTOR SHALL BE RESPONSIBLE FOR PROPER INSTALLATION, MONITORING, MAINTENANCE AND REMOVAL OF ALL TEMPORARY EROSION CONTROL MEASURES AND TAKING PRECAUTIONARY STEPS TO AVOID ANY SEDIMENT TRANSFER TO NEIGHBORING SITES OR WATERS OF THE STATE.
- 17. ALL SITE FILL SHALL MEET SPECIFICATION 31 23 23 FILL UNLESS NOTED OTHERWISE ON THE DRAWINGS.

SUBJECT PROPERTY:

TAX MAP PARCEL 233.-5-67 284 IDAHO AVENUE TOWN OF PLATTSBURGH, CLINTON COUNTY, NEW YORK

OWNER:

WEST SECOND STREET ASSOCIATES (WSSA), LLC 503 S. SAGINAW ST, SUITE 600 FLINT, MI 48502

APPLICANT:

U.S. GENERAL SERVICE ADMINISTRATION (GSA)

SLIBVEY MOTE

- 1. EXISTING PHYSICAL FEATURES AND BOUNDARIES SHOWN HEREIN ARE BASED ON PLAN ENTITLED "SURVEY MAP— WSSA, LLC", PREPARED BY DEAN H. LASHWAY, L.S., P.C. AND DATED 11/28/22.
- 2. TOPOGRAPHY SHOWN HEREIN ARE BASED ON CONTOUR INFORMATION PROVIDED BY DEAN H. LASHWAY, L.S., P.C. IN JULY 2023.
- 3. ENGINEERING VENTURES HAS NOT PERFORMED ANY BOUNDARY OR TOPOGRAPHIC SURVEYS. THE PROPERTY LINES, EASEMENTS, AND OTHER REAL PROPERTY DESCRIPTIONS PROVIDED ON THESE PLANS DO NOT DEFINE LEGAL RIGHTS OR MEET LEGAL REQUIREMENTS FOR A LAND SURVEY AS DESCRIBED IN NY STATUTES, AND SHALL NOT BE USED AS THE BASIS OF ANY LAND TRANSFER OR ESTABLISHMENT OF ANY PROPERTY RIGHT.
- 4. CONTOUR INTERVAL DEPICTED HEREIN IS ONE (1) FOOT.
- 5. UTILITIES SHOWN DO NOT PURPORT TO CONSTITUTE OR REPRESENT ALL UTILITIES LOCATED UPON OR ADJACENT TO THE SURVEYED PREMISES. EXISTING UTILITIES SHOWN ON THE PLANS WERE TAKEN FROM FIELD OBSERVATIONS OF VISIBLE UTILITIES AND PREVIOUS MAPS AND RECORD UTILITY DRAWINGS AND NOT GUARANTEED TO BE ACCURATE OR COMPLETE.

ese plans and details are the	Approved Detailed Preliminary Plans for construction of:
	(proposed site plan).
34	76-31-31-31-31-31-31-31-31-31-31-31-31-31-

As per Planning Board Resolution No, dated	, these Detailed
Preliminary Site Plans have been reviewed and are certifie	d to be in compliance with Planning Board
conditions.	

Town Planning Department Date

Planning Board Chairman Date

"As-Built" construction drawings in accordance with Article VII Section 7.12 of the Town of Plattsburgh Zoning Ordinance shall be prepared and accepted by the Town of Plattsburgh prior to the issuance of a Certificate of Occupancy.

Site Plan improvements shall be constructed in accordance with and as shown on the approved Detailed Preliminary Site Plan.

Owner/Developer Date

Note: The issuance of this authorization, approval or permit does not relieve the project applicant/sponsor of any responsibility for obtaining any other approvals/permits from any other federal, state, or local agency including the US Army Corps of Engineers (USACOE), and any utility companies which may be required.

STUDIO

30 N Gould Street, Ste N Sheridan, WY 82801 732.986.3402 www.studio40seven.com

LICENSE NO:

James A. Smith AIA, NCARB

AI02091100 NJ 045303 NY ARC08023 IA

Date

Studio 40 Seven LLC retains ownership of this drawing which has been prepaired exclusively for the construction of the particular project shown and its use is limited to that specific purpose. Unathorized reproduction or other use of this drawing is prohibited.

© Studio 40 Seven LLC

CIVIL & STRUCTURAL:

ENGINEERING VENTURES

ADDRESS: 208 FLYNN AVENUE
BURLINTON, VT 05401
PHONE: (802) 863-6225

MED.

SALEM ENGINEERING

ADDRESS: 114 SUNSET ROAD
CHARLOTTE, VT 05445
PHONE: (802) 310-6525

LOW VOLTAGE:

IC THOMASSON ASSOCIATES
ADDRESS: 2950 KRAFT DRIVE
NASHVILLE, TN 37204
PHONE: (615) 346-3494

No.	Description	Date
4	DID L1 REVISED + L2	10/25/2024
		-
		+
		+

WSSA PLATTSBURGH LLC

PLATTSBURGH GSA

284 IDAHO AVENUE
PLATTSBURGH, NY

NOT FOR CONSTRUCTION

Site Legend and Notes

 Project Number
 EV# 23054

 Date
 08/26/2025


 Drawn By
 PEG (EV)


 Checked By
 PEG (EV)

C-001

Scale AS NOTED

NOT FOR CONSTRUCTION

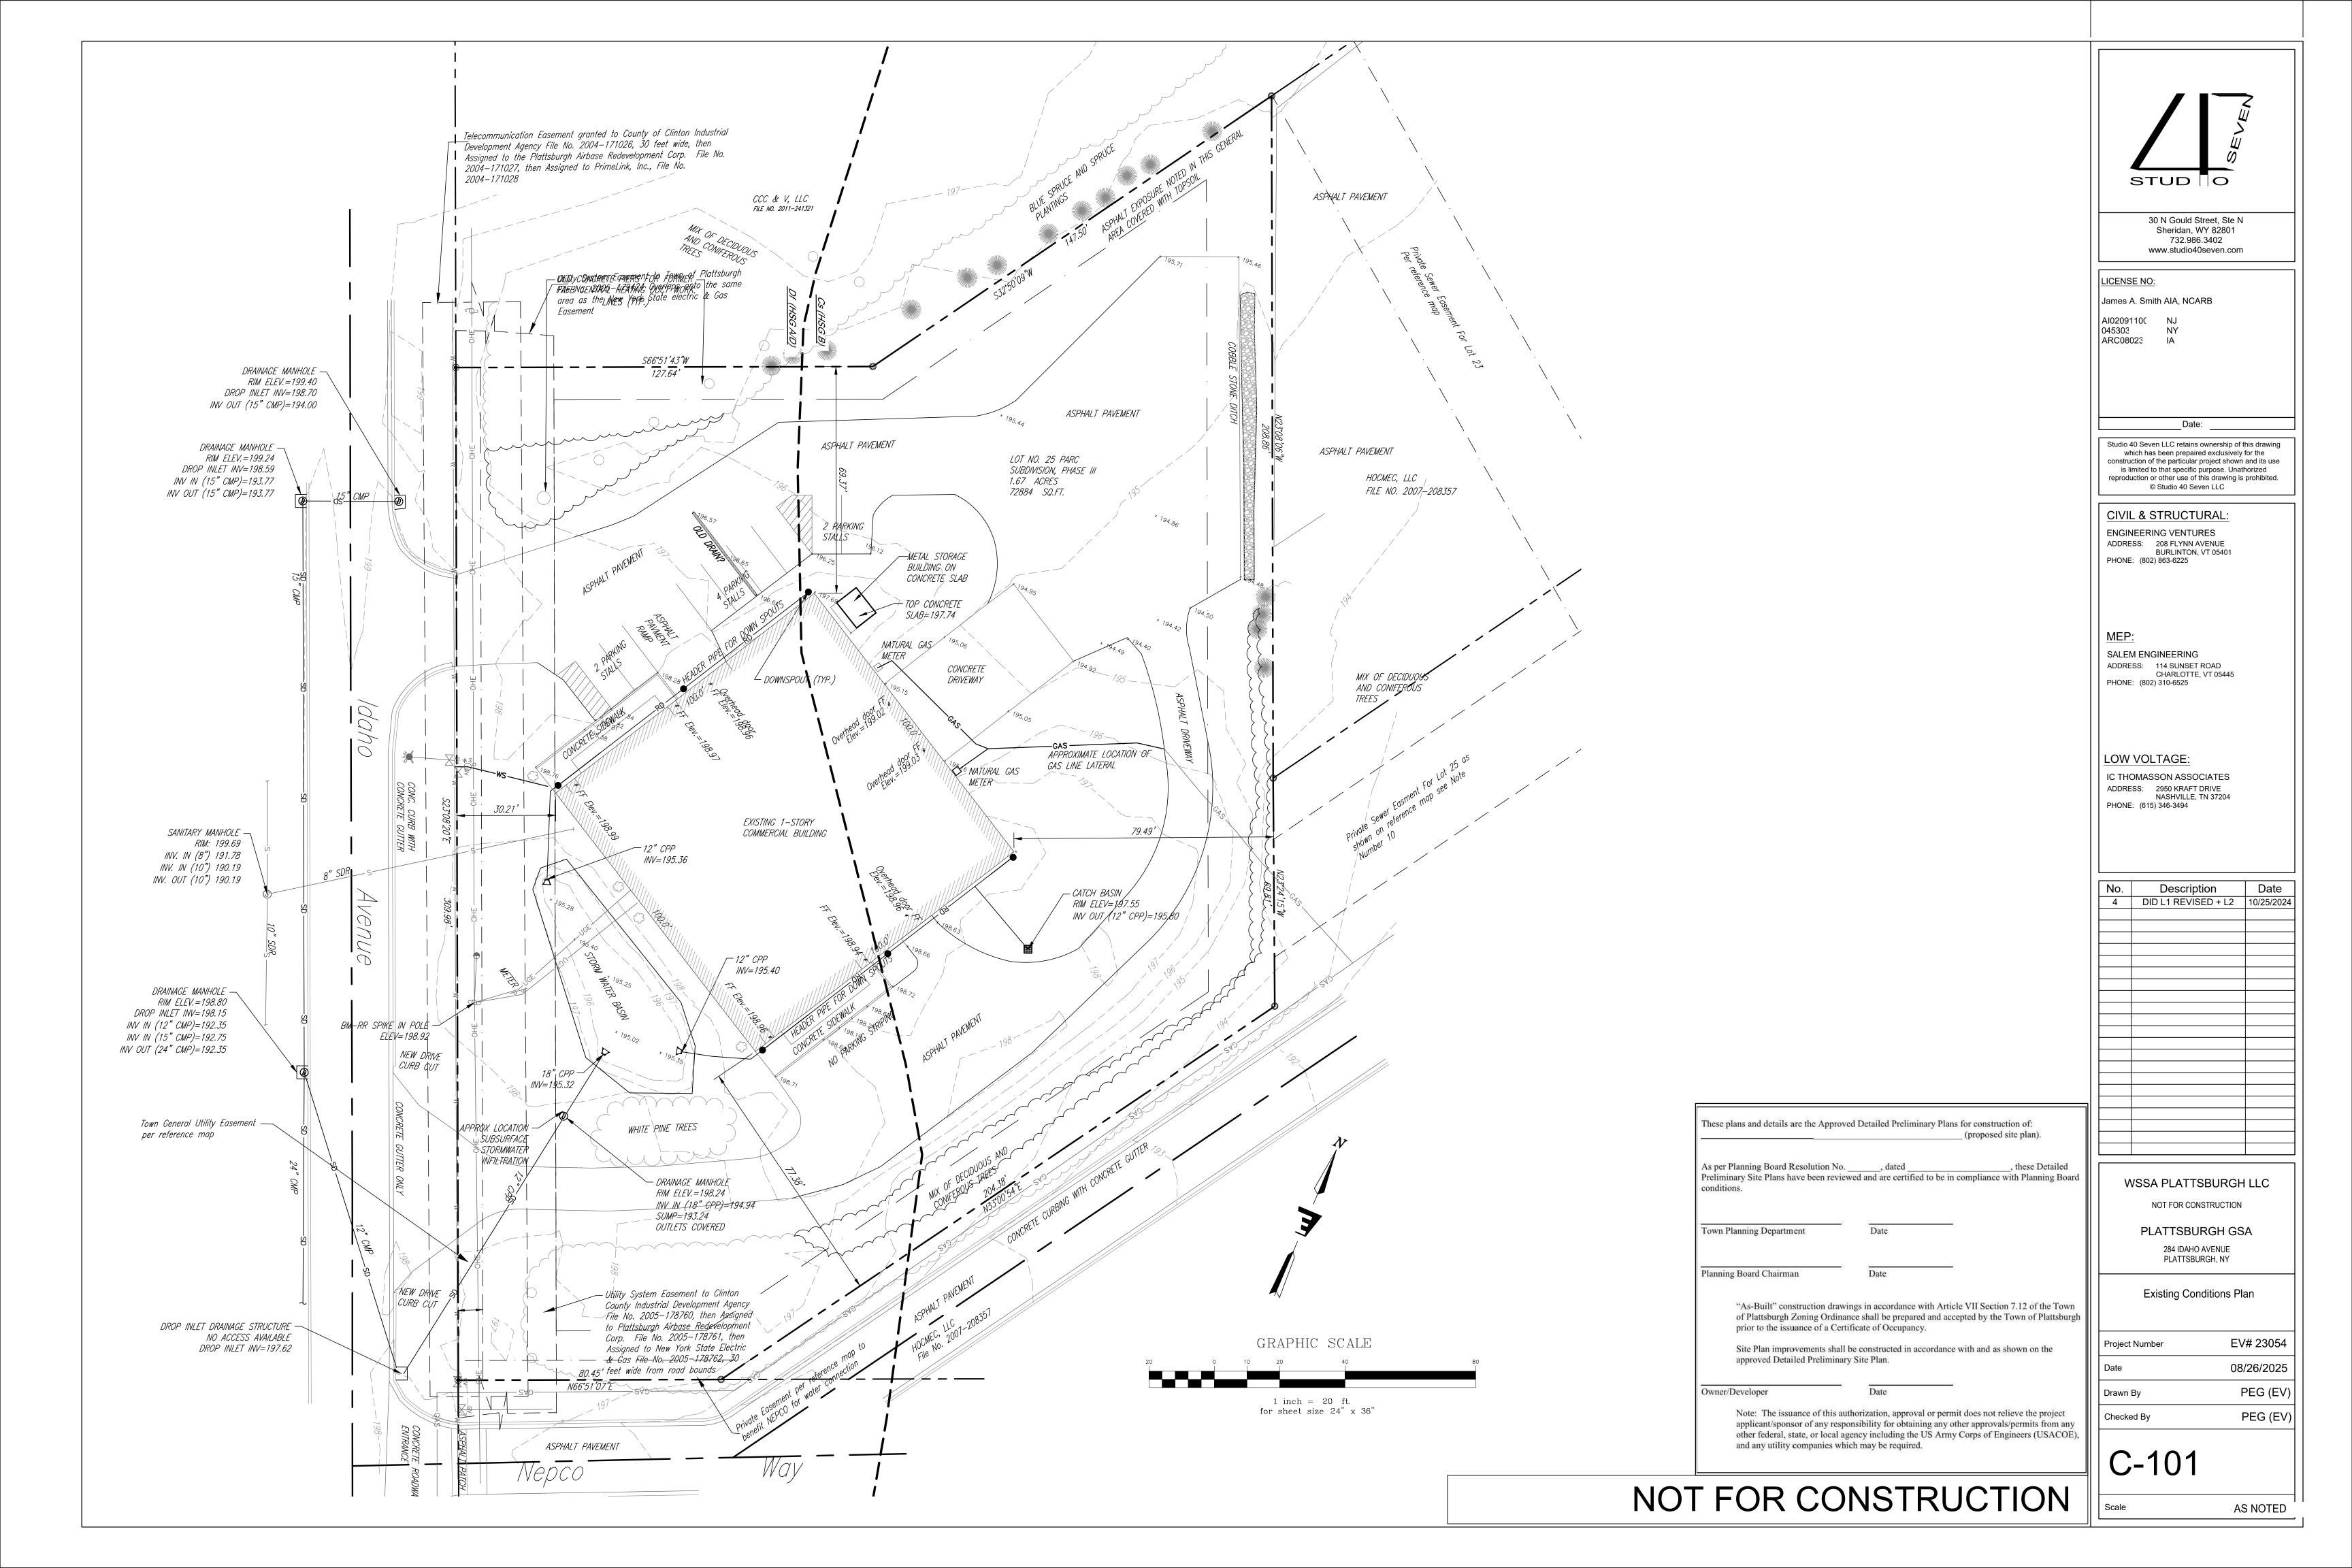

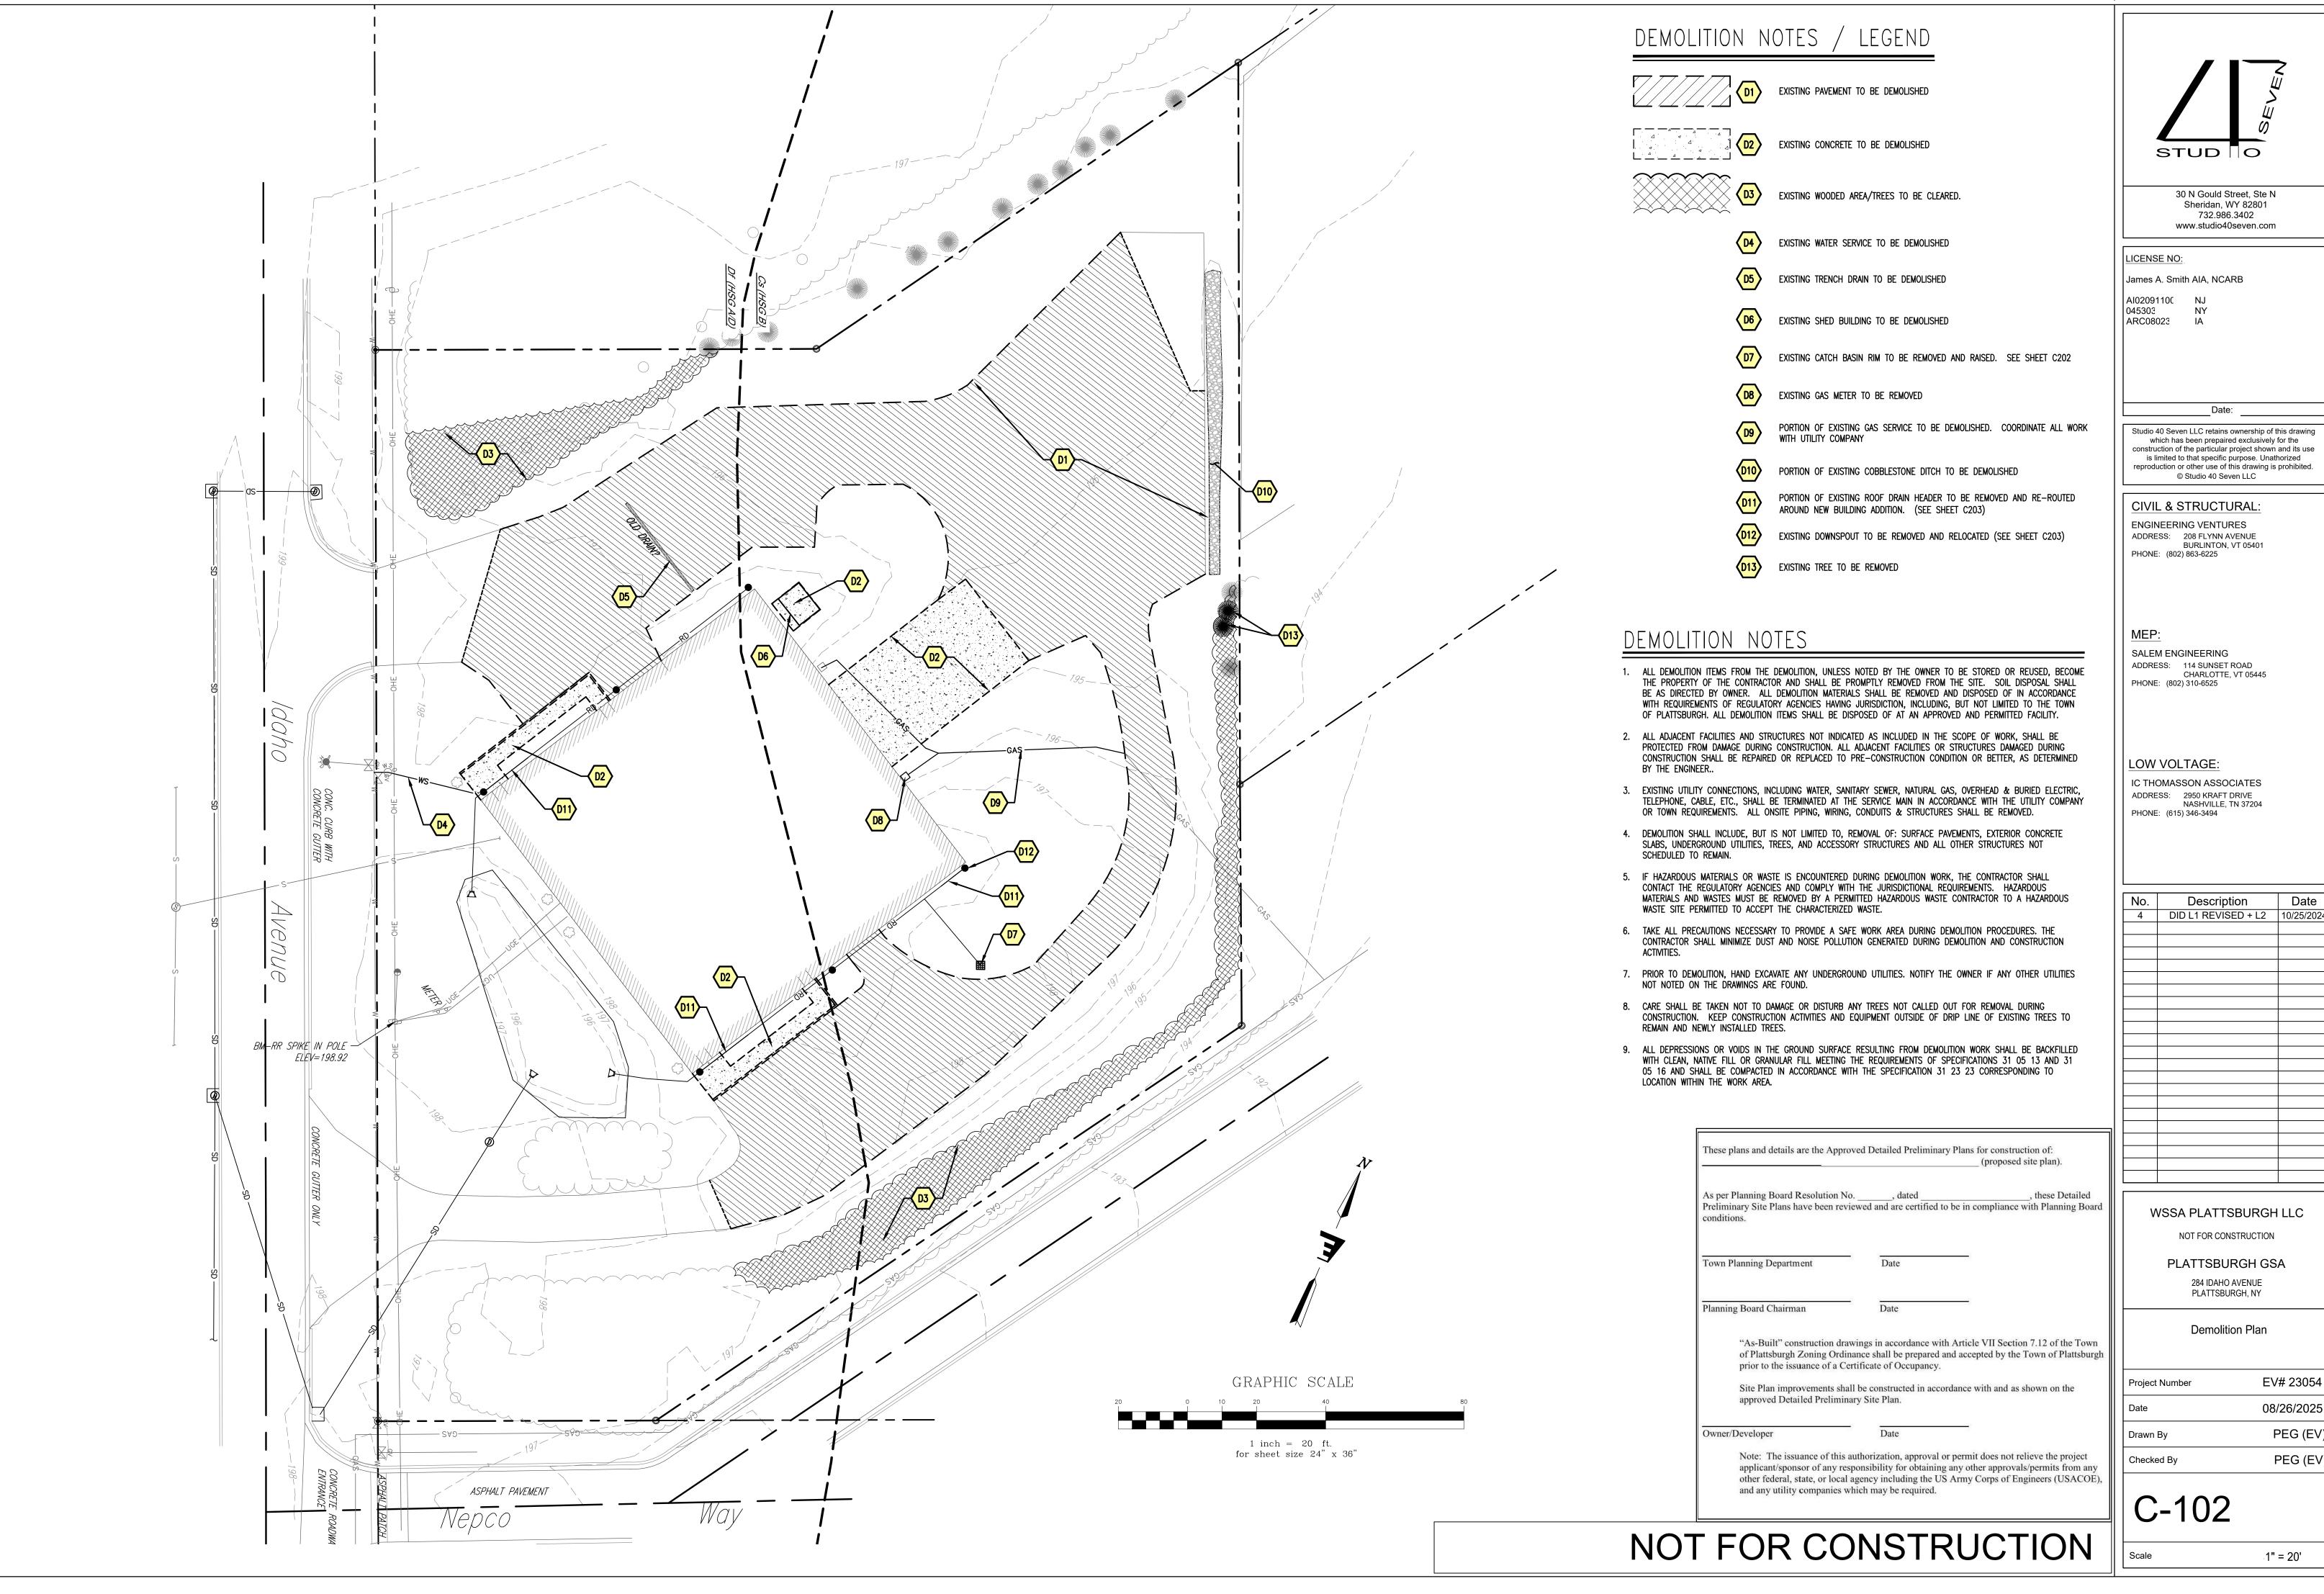



Studio 40 Seven LLC retains ownership of this drawing which has been prepaired exclusively for the construction of the particular project shown and its use is limited to that specific purpose. Unathorized reproduction or other use of this drawing is prohibited.


No.	Description	Date
4	DID L1 REVISED + L2	10/25/2024
		L

EV# 23054 08/26/2025 PEG (EV) PEG (EV)

1" = 20'

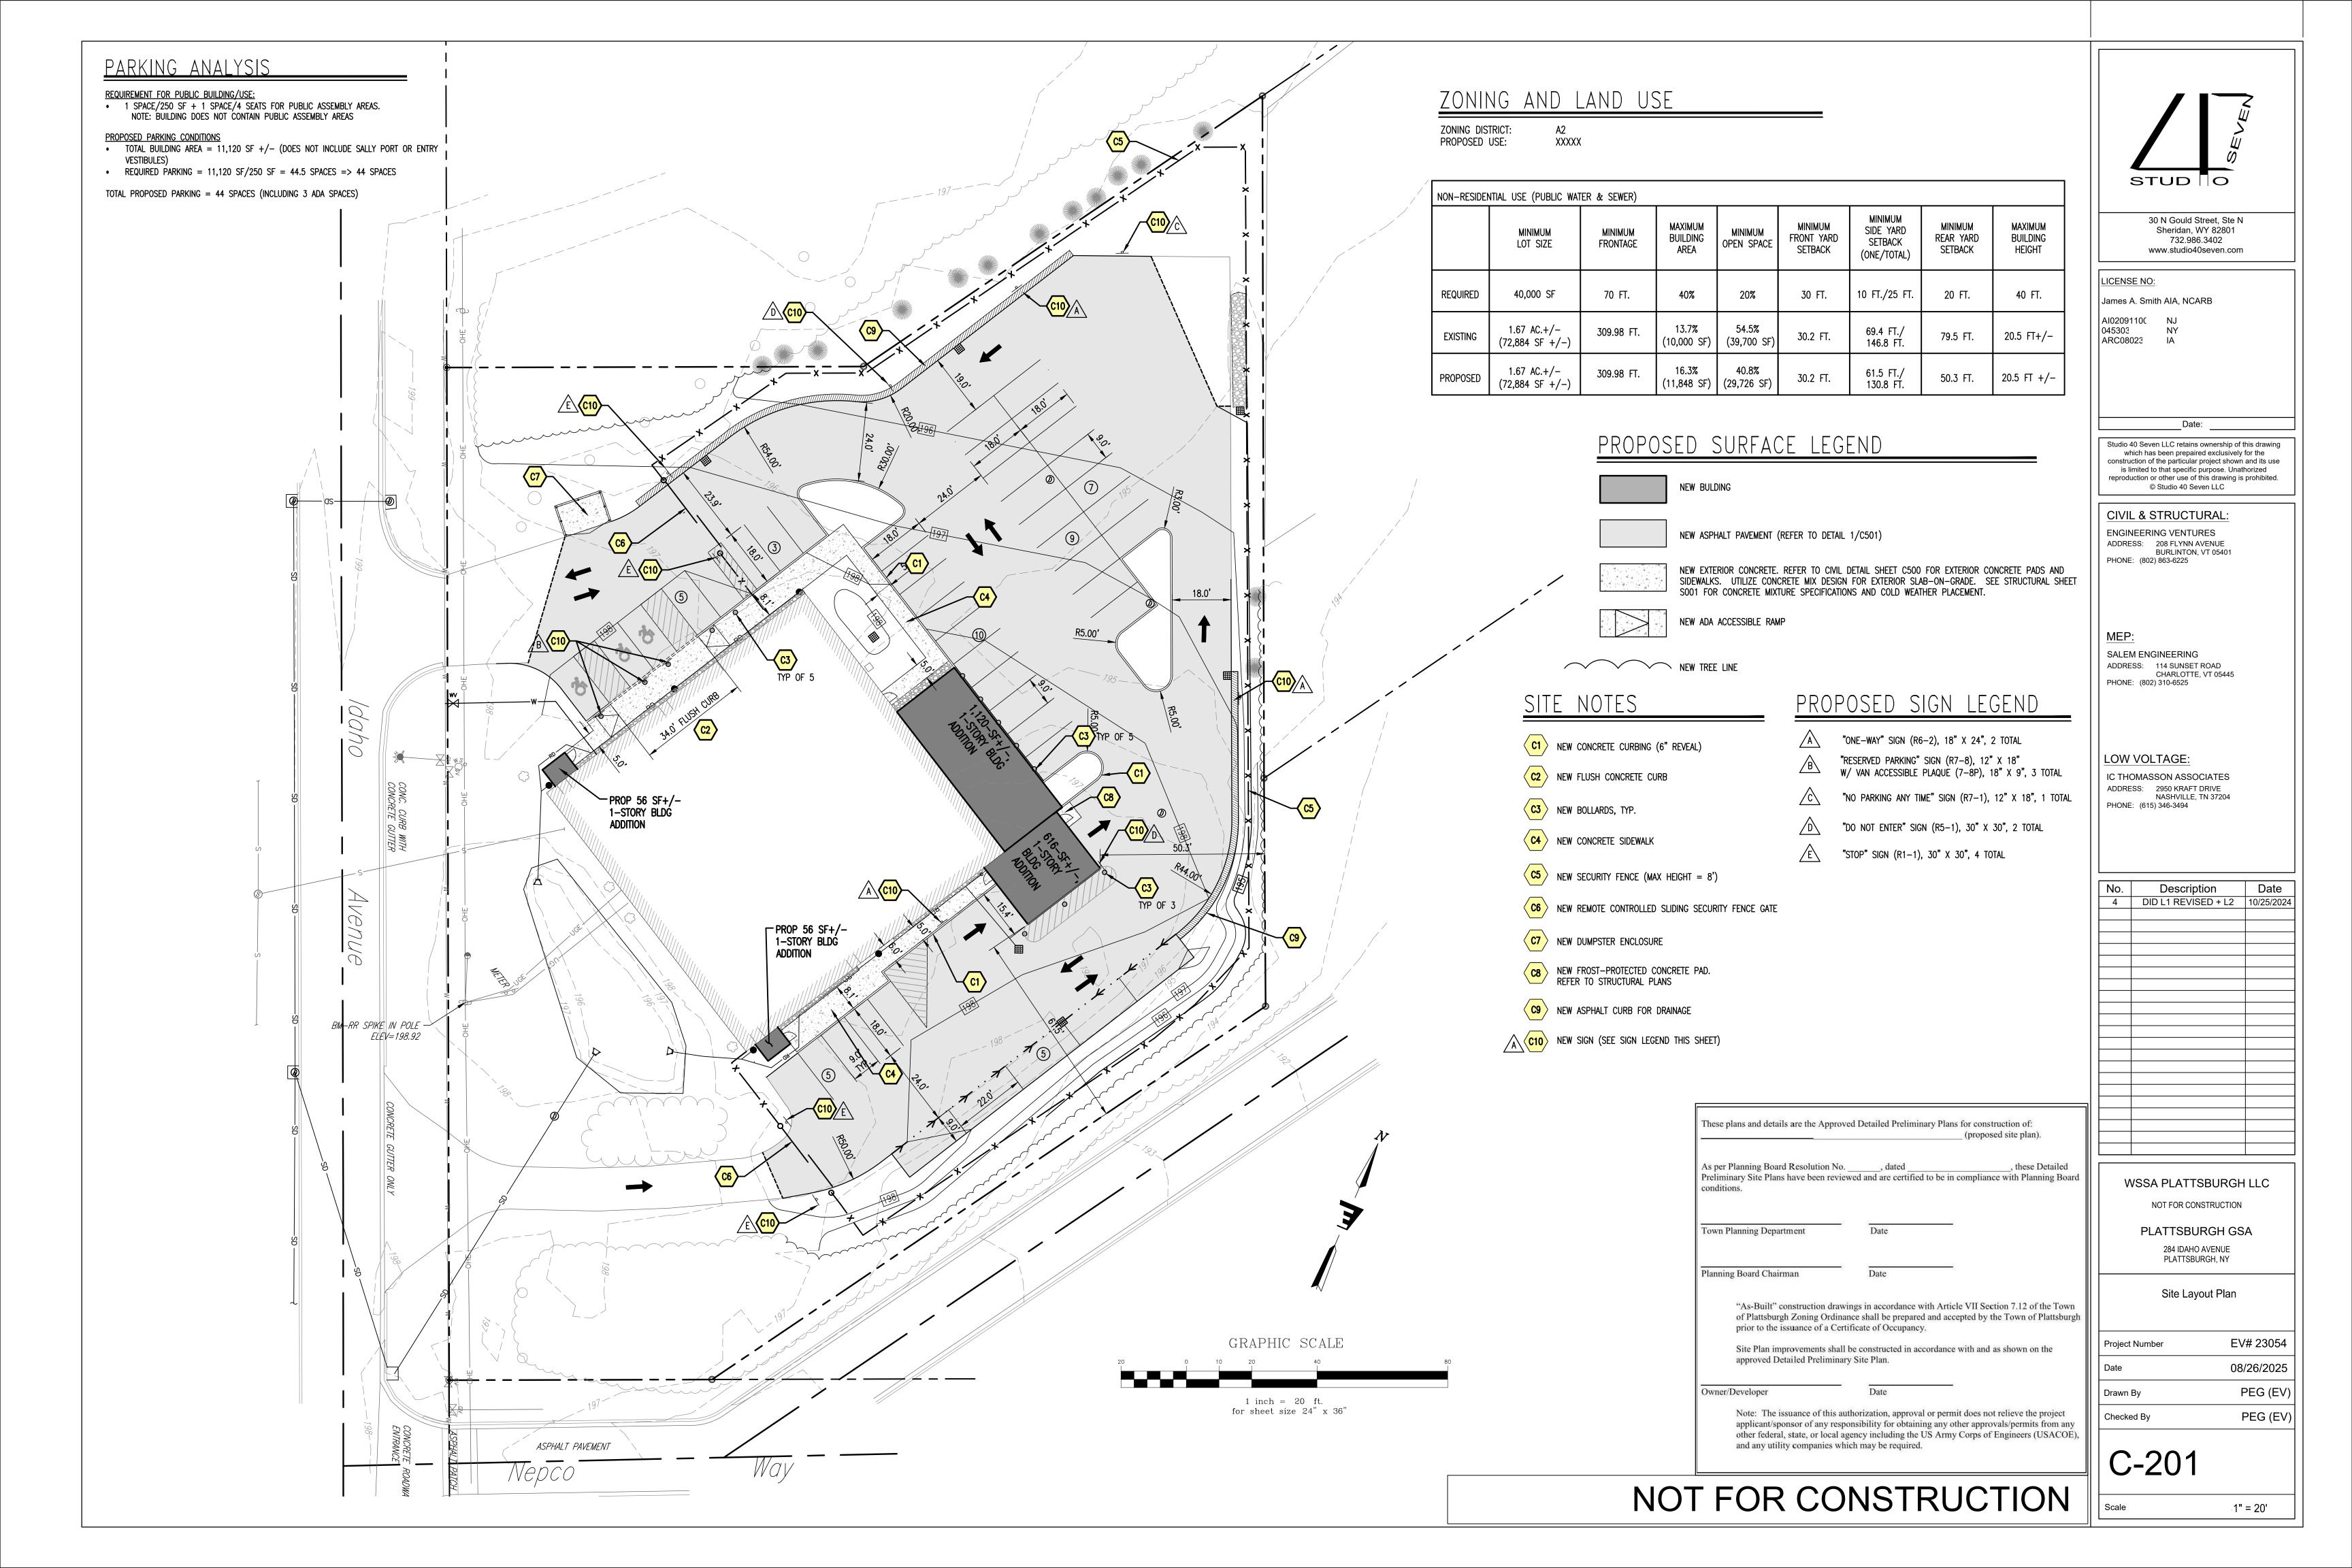


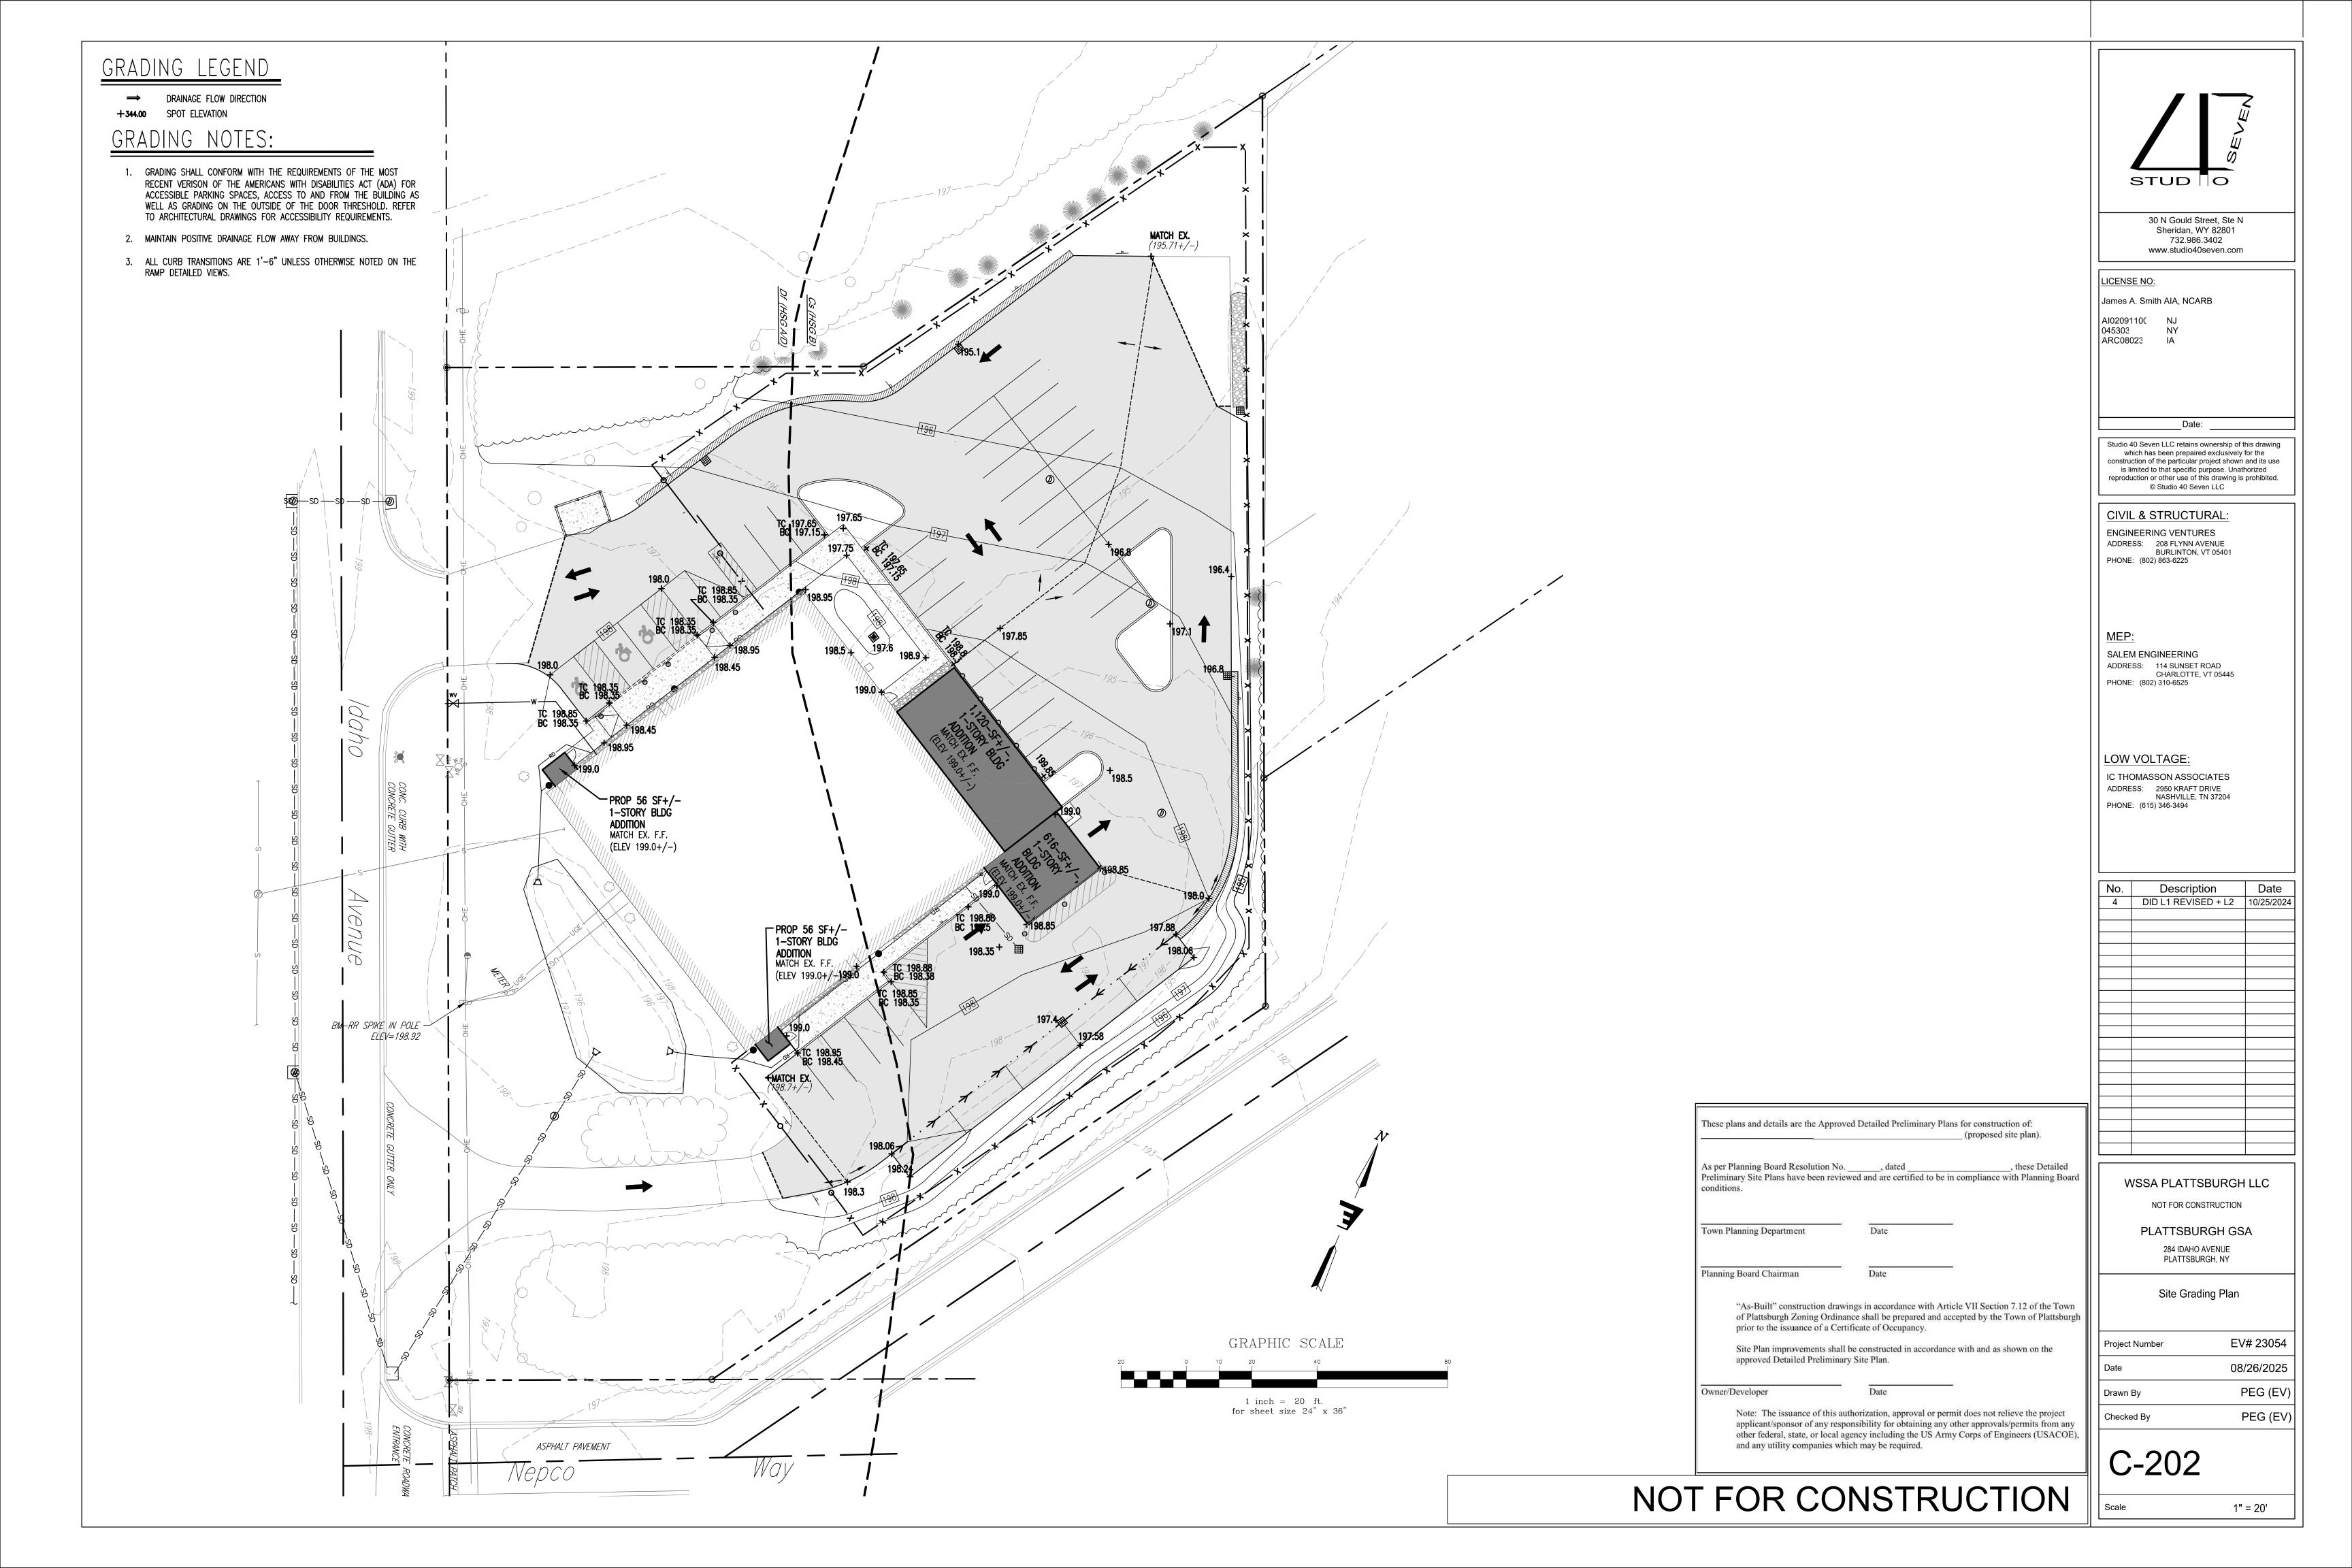


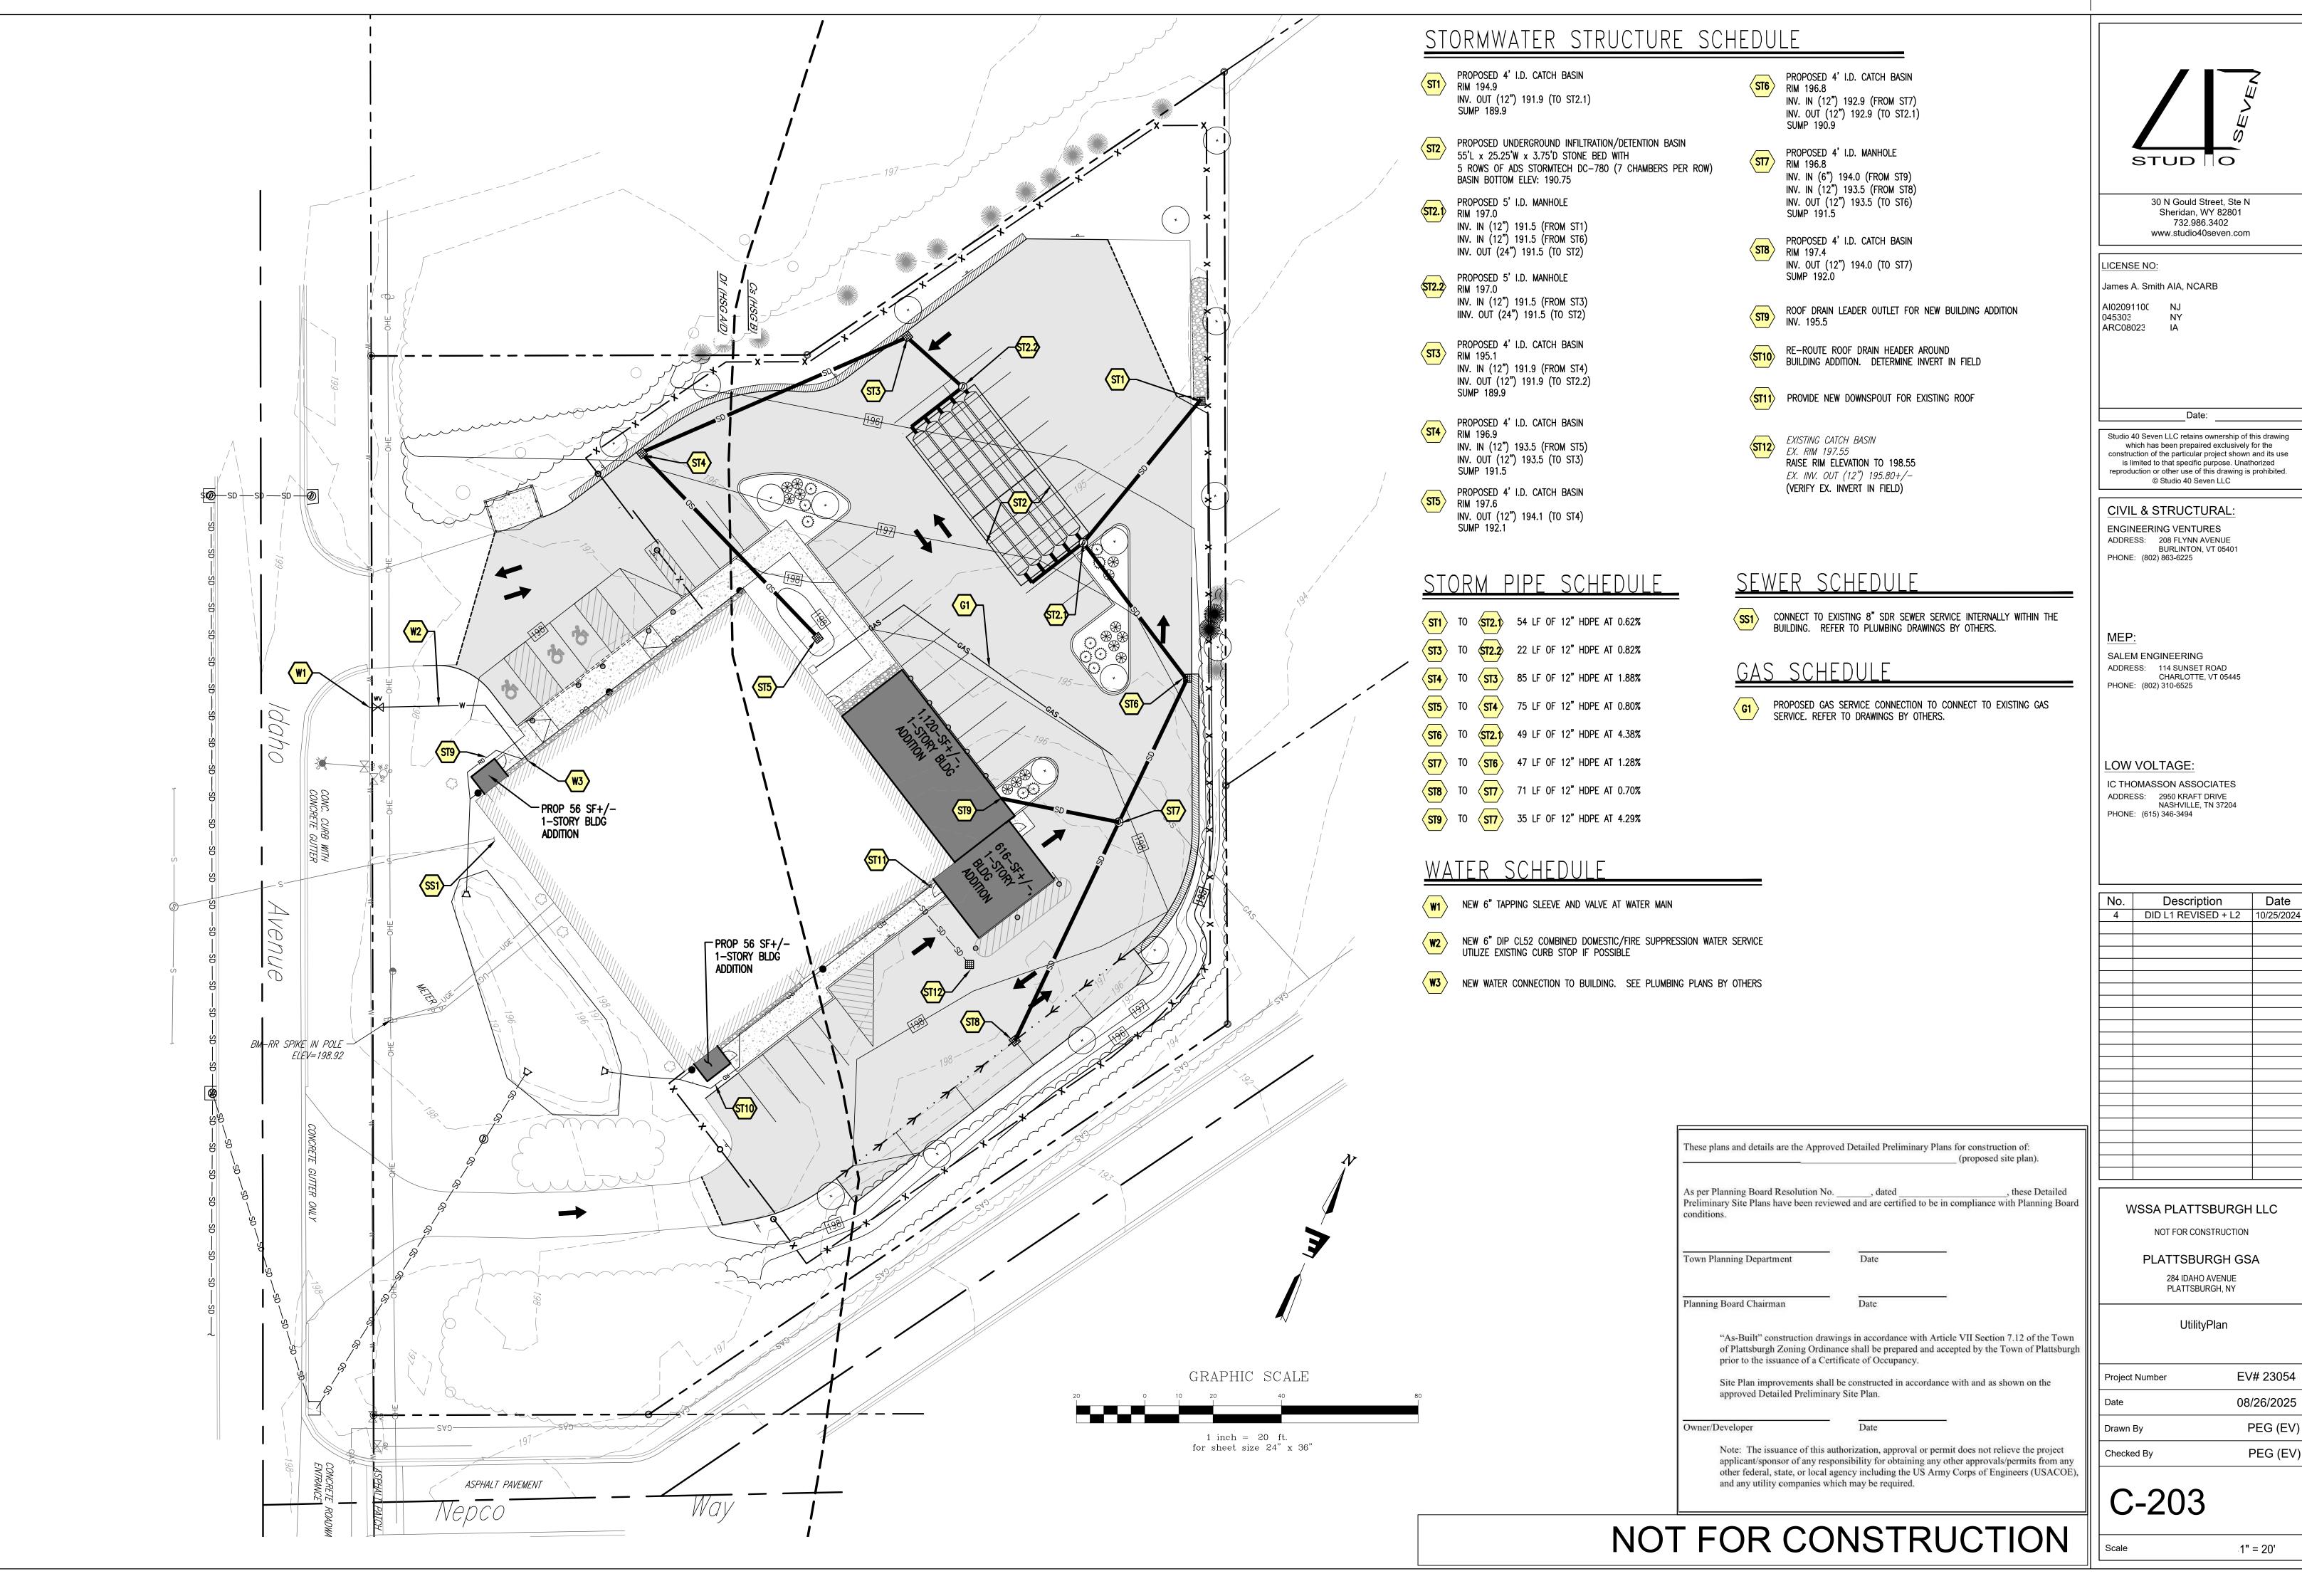


4	DID L1 REVISED + L2	10/25/2024
		†
		
		†
		
		

EV# 23054 08/26/2025 PEG (EV)

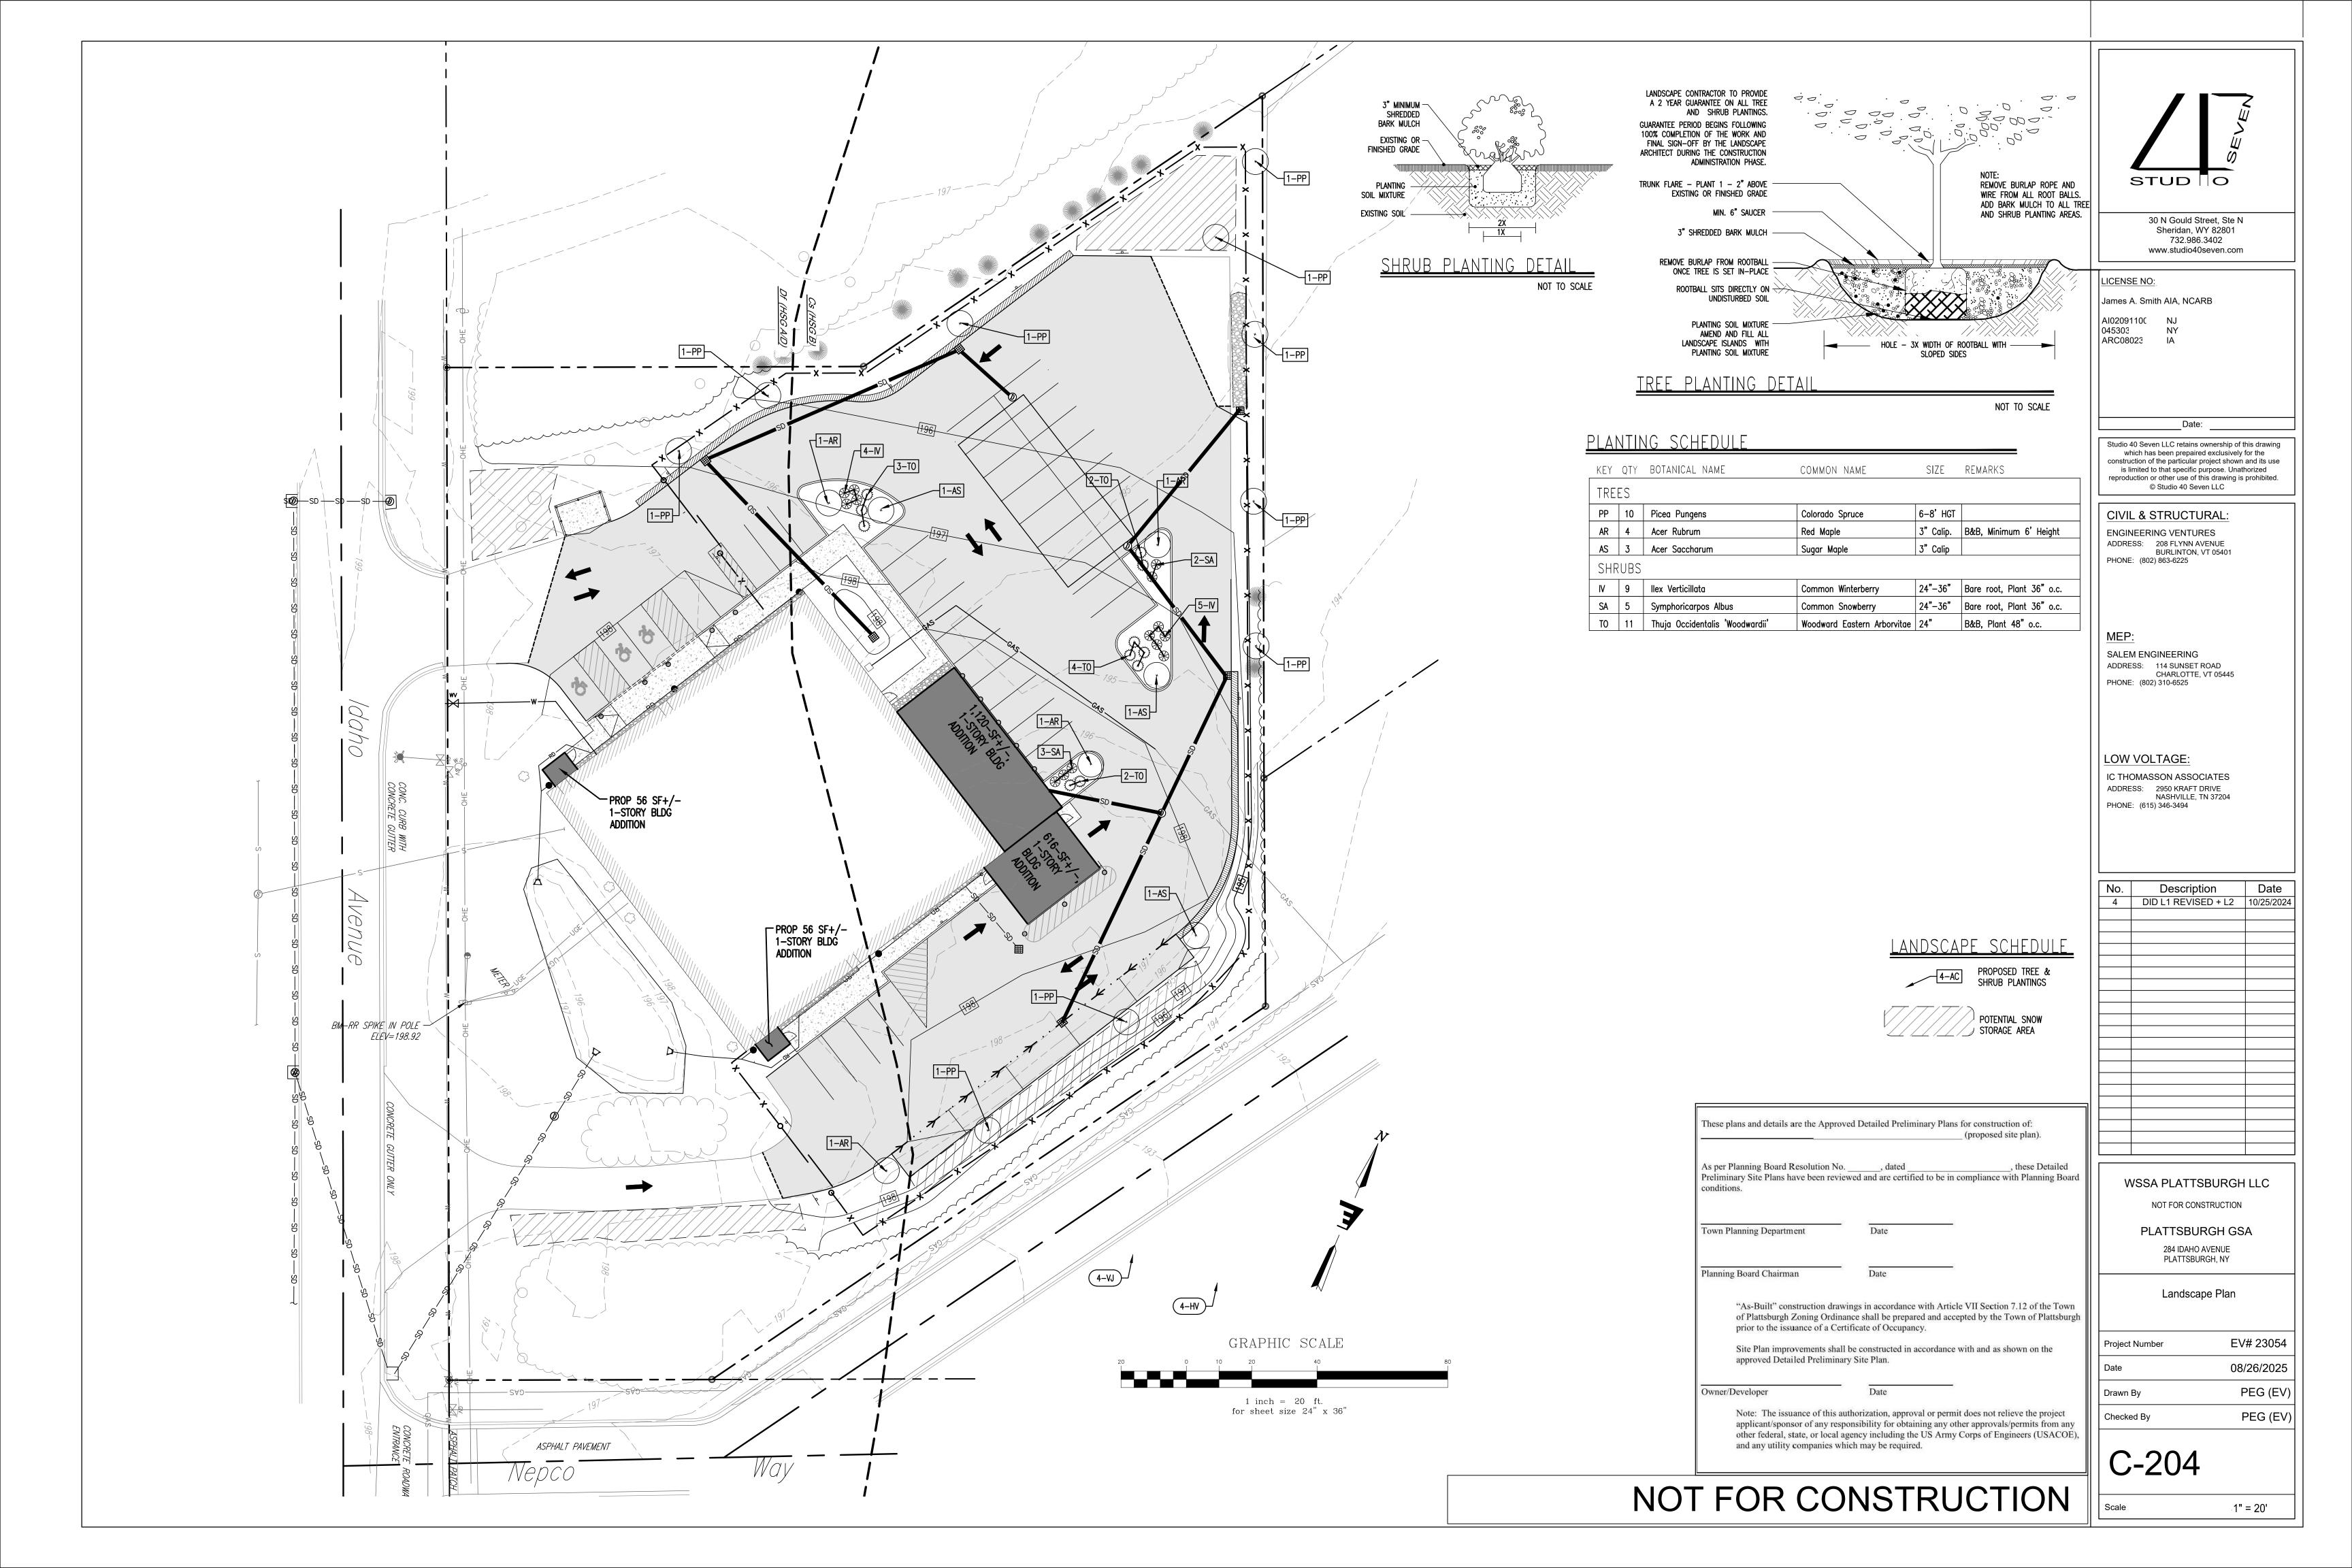


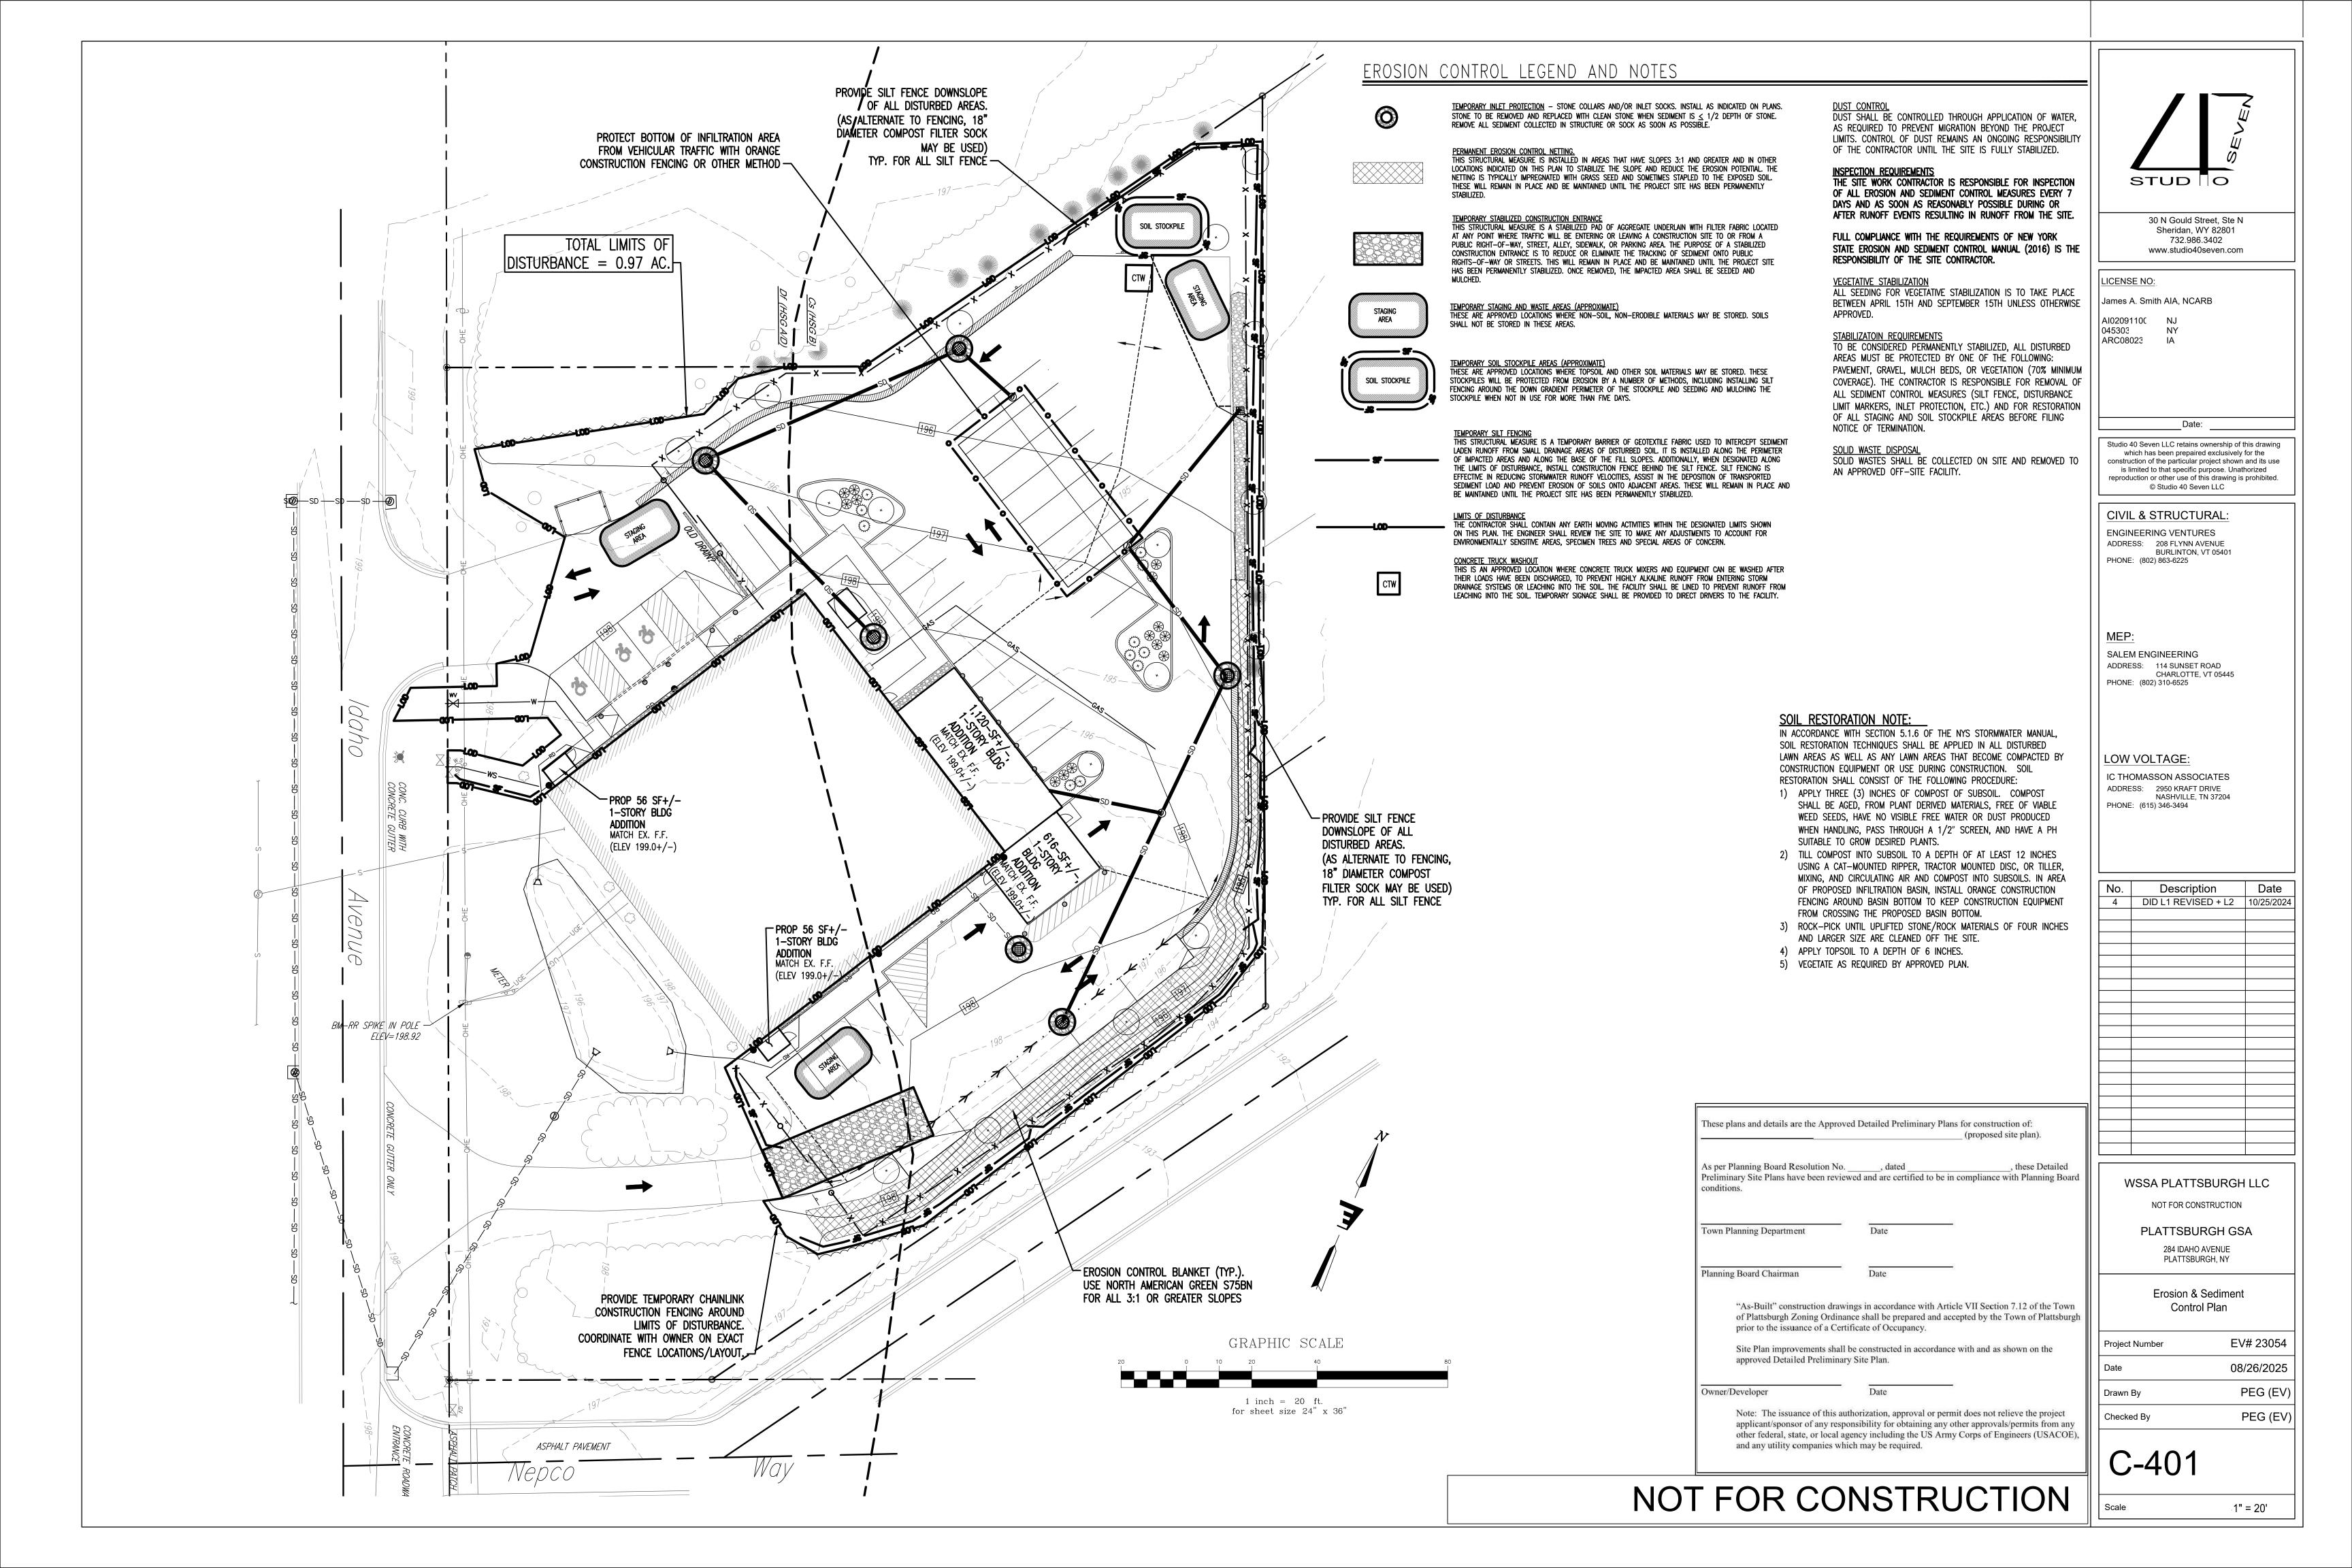

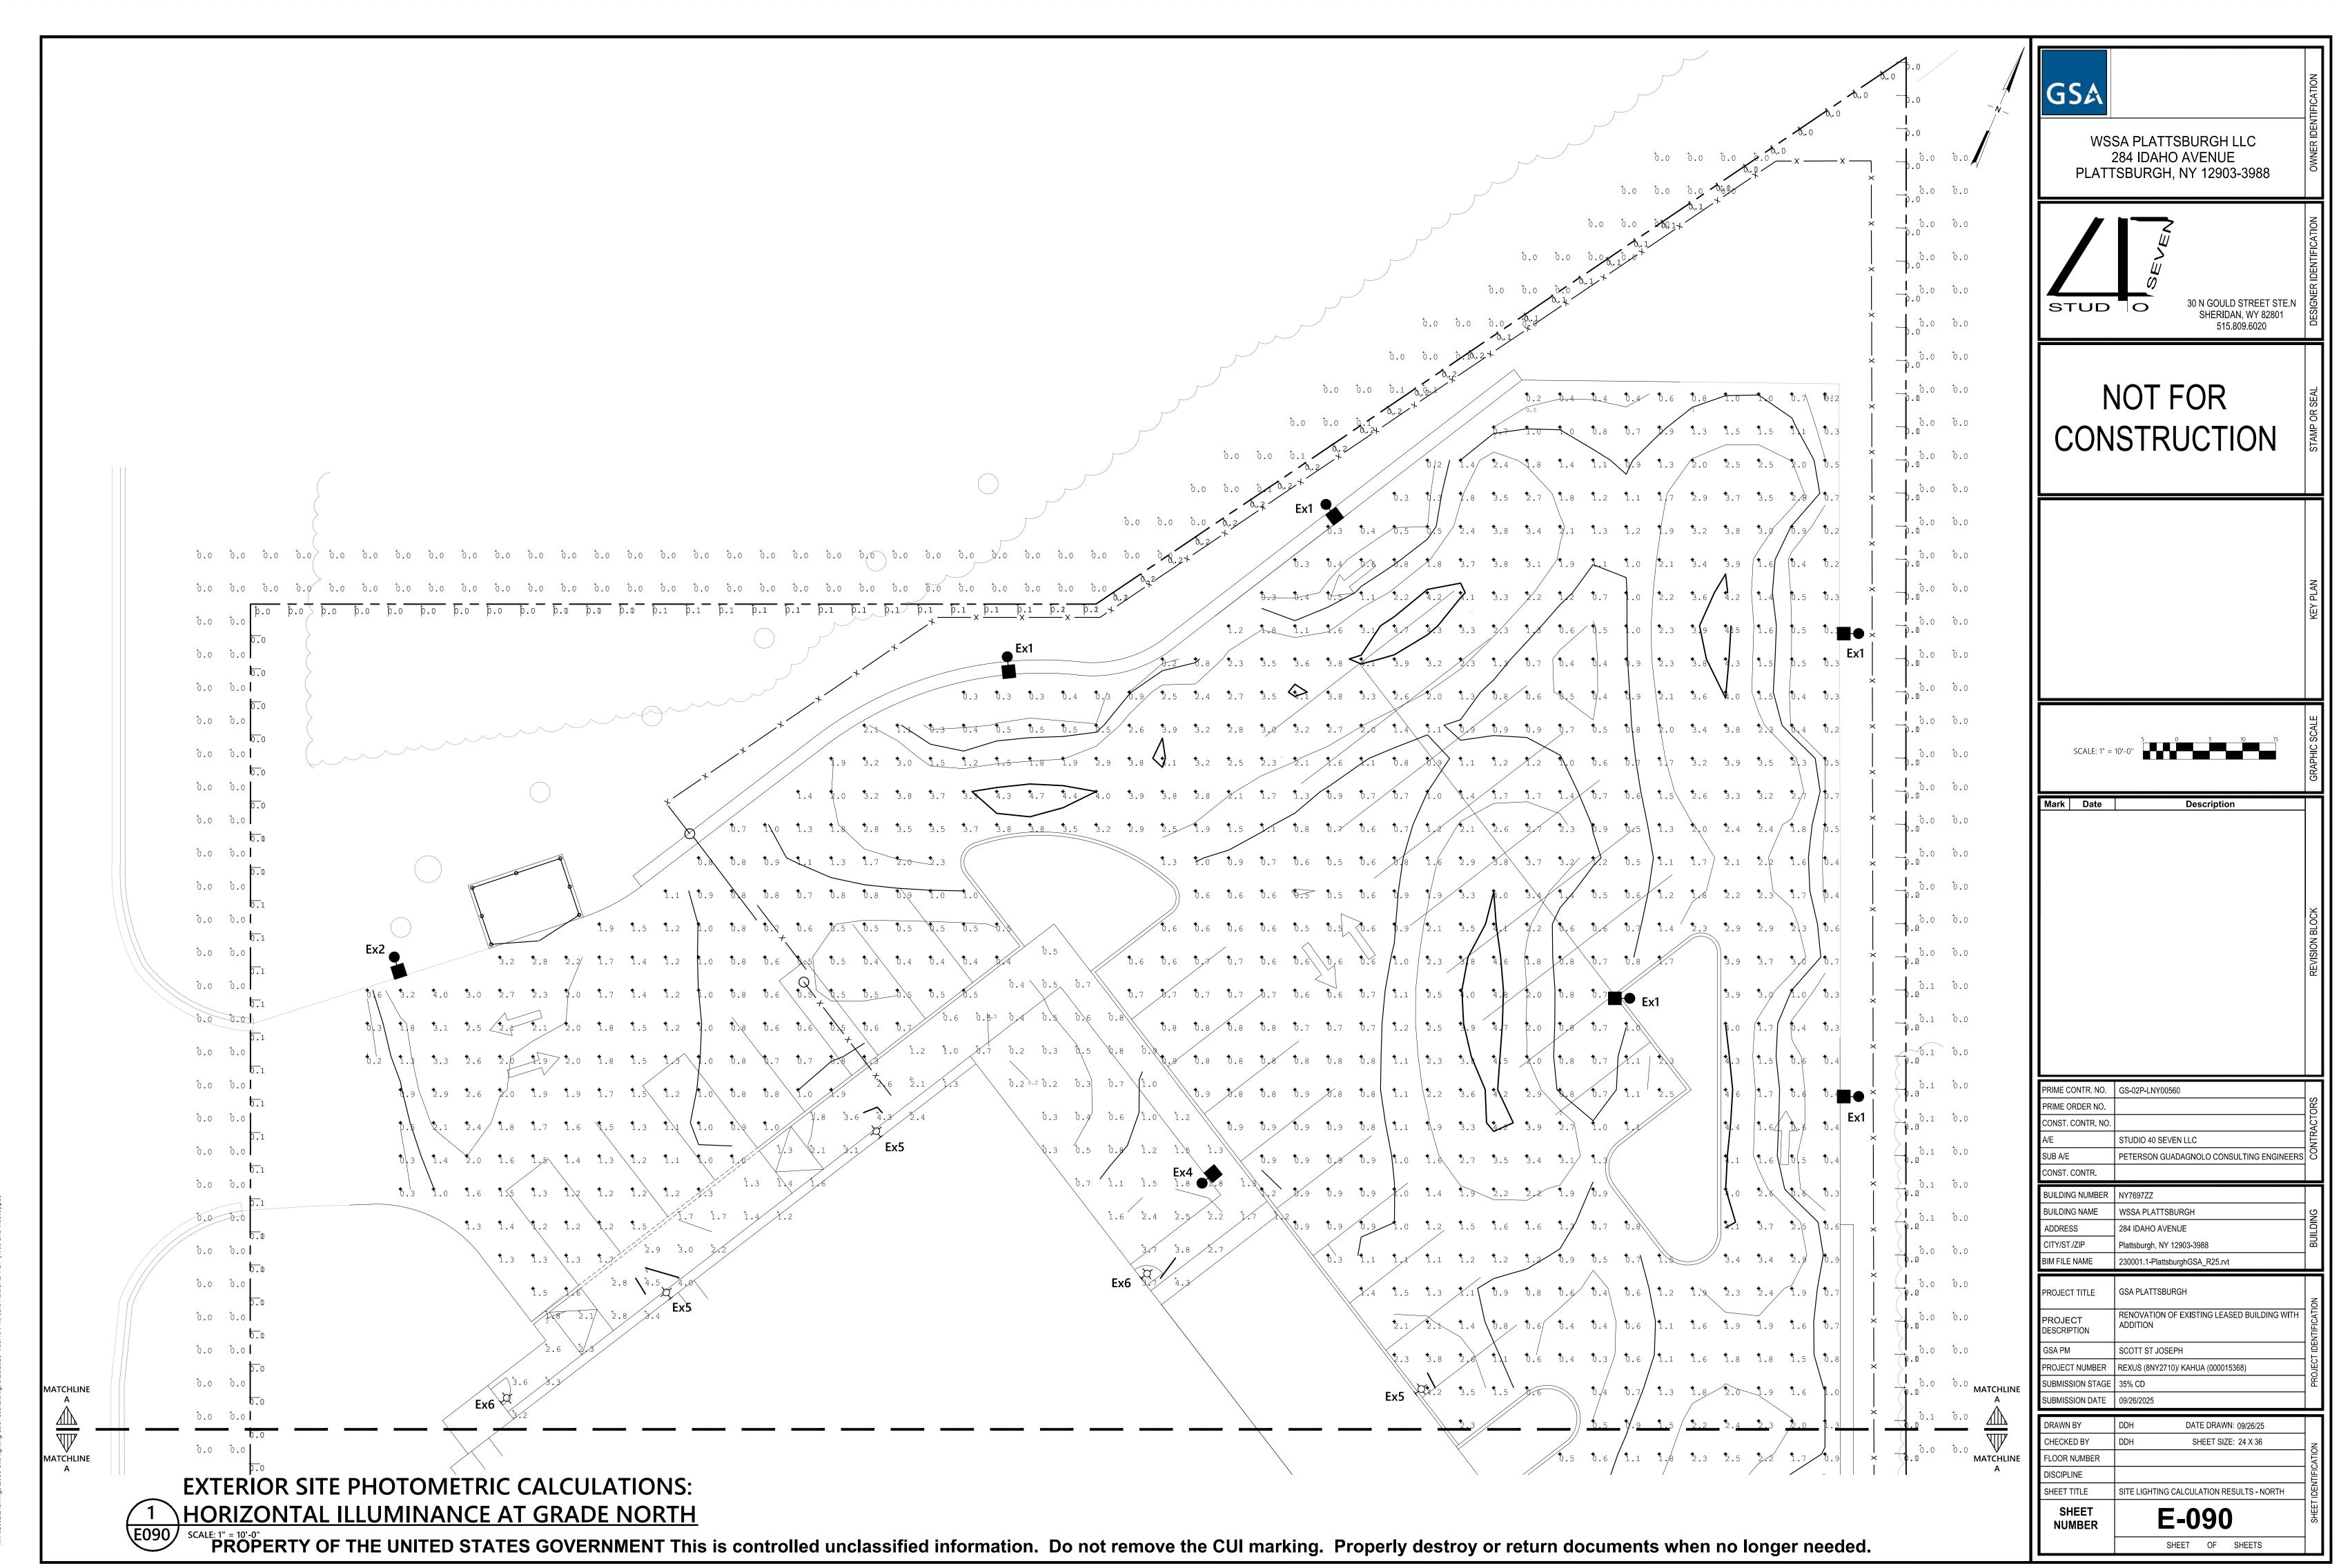

702002)Drawings)E090 Site lighting calc results, dwg. 9/26/2025 4:53:48 PM. dan. AutoC.


N:\702002\Drawings\E090 Site lighting calc results.dwg, 9/26/2025 4:54:06 PM, dan, AutoCAD PDF (We

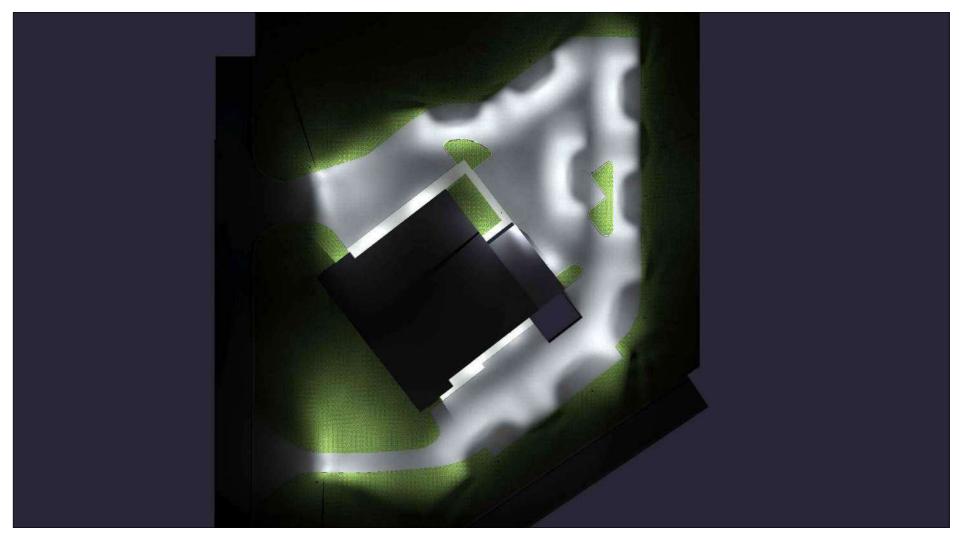

EXTERIOR LIGHT CALCULATION

1 RENDERING - TOP VIEW, COLOR

E092 NOT TO SCALE

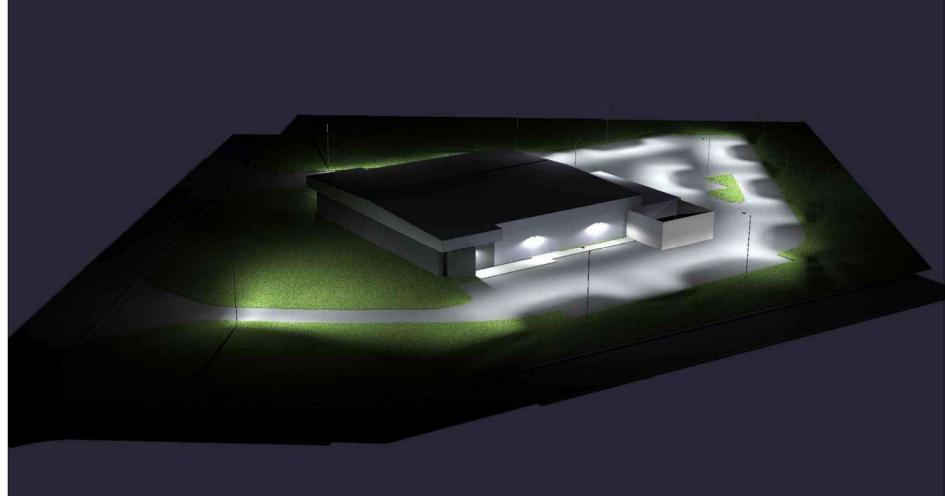


EXTERIOR LIGHT CALCULATION

3 RENDERING - SOUTH VIEW, COLOR

E092 NOT TO SCALE




5 RENDERING - NORTH VIEW, COLOR E092 NOT TO SCALE

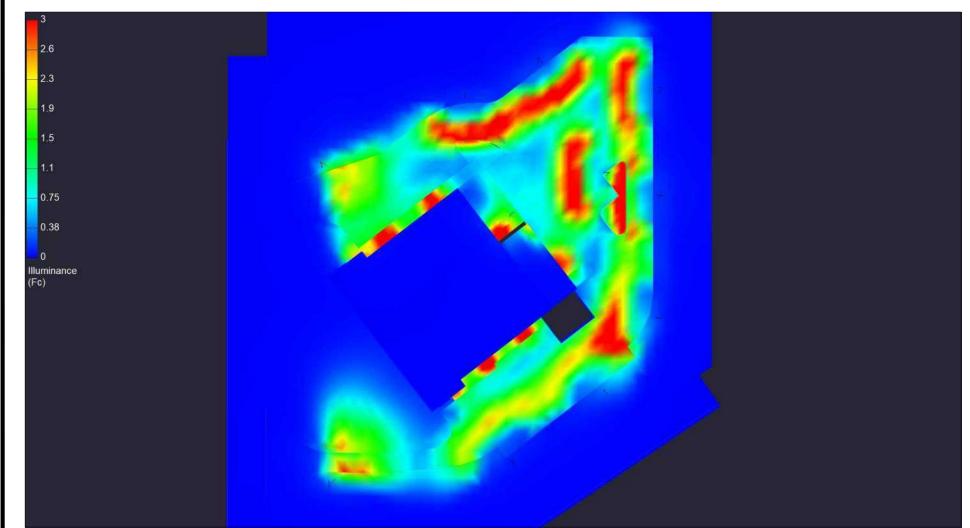

EXTERIOR LIGHT CALCULATION


2 RENDERING - TOP VIEW, PSEUDO-COLOR
E092 NOT TO SCALE

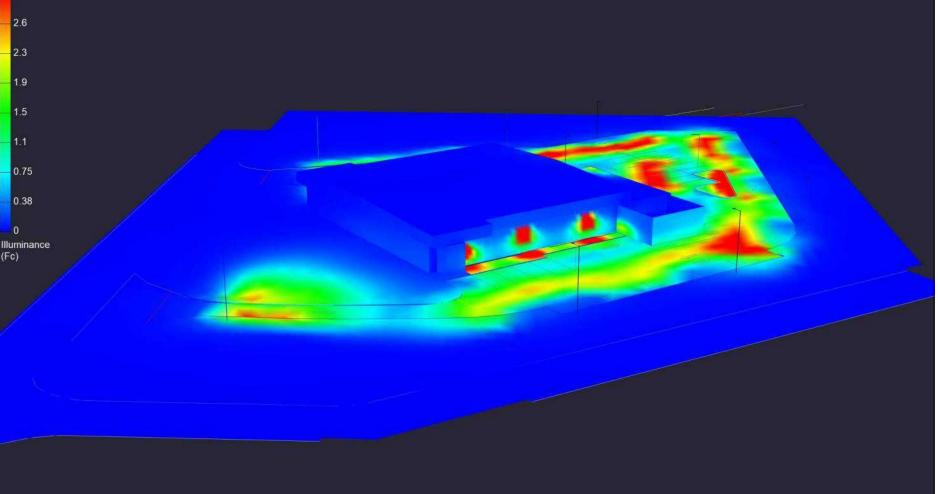

EXTERIOR LIGHT CALCULATION

4 RENDERING - SOUTH VIEW, PSEUDO-COLOR


E092 NOT TO SCALE

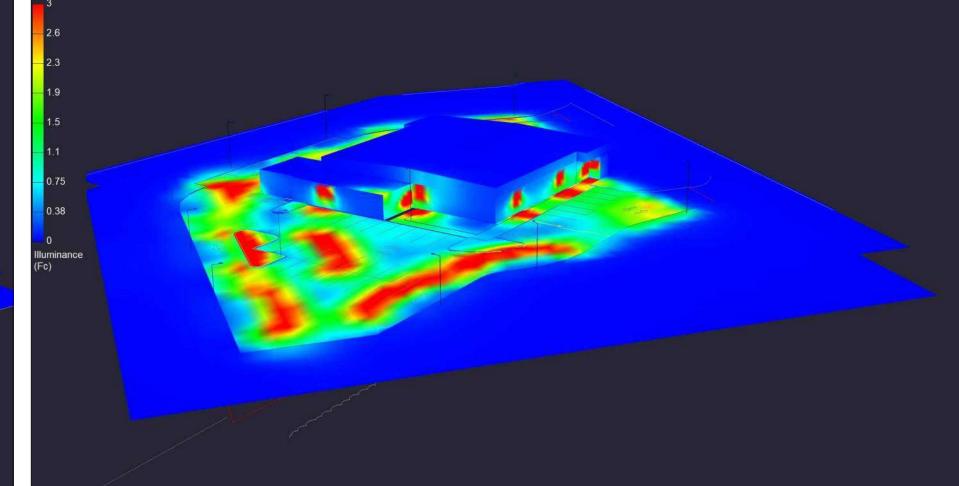


EXTERIOR LIGHT CALCULATION

6 RENDERING - NORTH VIEW, PSEUDO-COLOR

E092 NOT TO SCALE

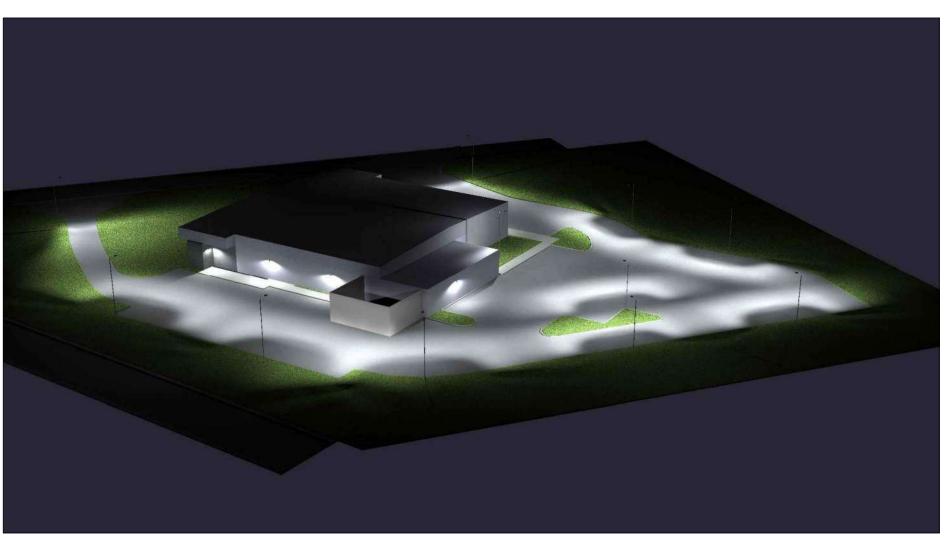


7 RENDERING - EAST VIEW, COLOR

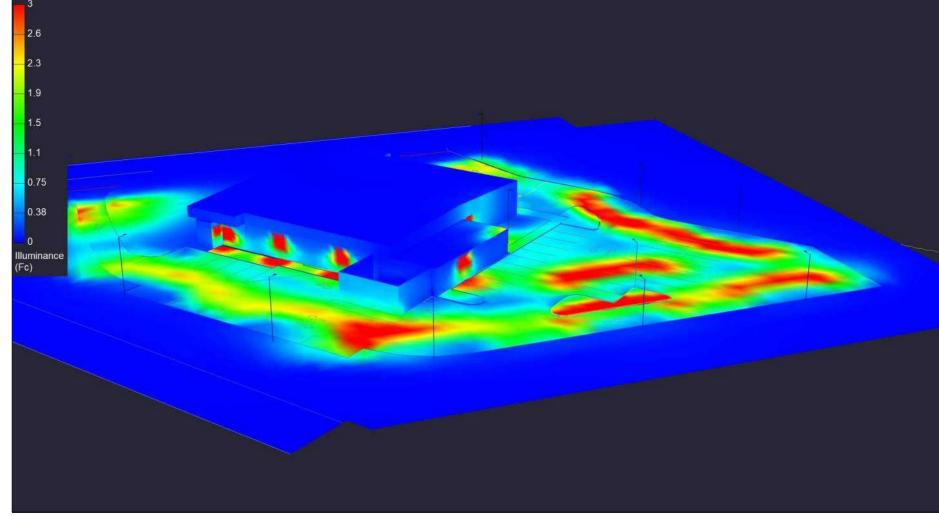

8 RENDERING - EAST VIEW, PSEUDO-COLOR E092 NOT TO SCALE

Label	CalcType	Units	Avg	Max	Min	Avg/Min	Max/M
East Property Line	Illuminance	Fc	0.05	0.3	0.0	N.A.	N.A.
Horizontal light trespass perimeter	Illuminance	Fc	0.00	0.1	0.0	N.A.	N.A.
North Property Line	Illuminance	Fc	0.10	0.2	0.0	N.A.	N.A.
Parking and drive lanes horizontal	Illuminance	Fc	1.59	4.8	0.2	7.95	24.00
South Property Line	Illuminance	Fc	0.05	0.1	0.0	N.A.	N.A.
Walkways horizontal	Illuminance	Fc	1.88	4.5	0.2	9.40	22.50
West Property line	Illuminance	Fc	0.03	0.1	0.0	N.A.	N.A.

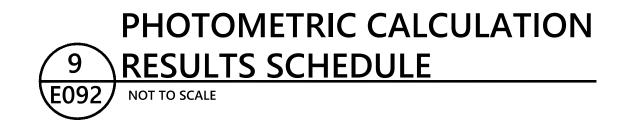




MIME ORDER NO. INST. CONTR. NO. E STUDIO 40 SEVEN LLC IB A/E PETERSON GUADAGNOLO CONSULTING ENGINEERS INST. CONTR. JILDING NUMBER NY7697ZZ JILDING NAME WSSA PLATTSBURGH DDRESS 284 IDAHO AVENUE TY/ST./ZIP Plattsburgh, NY 12903-3988 M FILE NAME 230001.1-PlattsburghGSA_R25.rvt OJECT TITLE GSA PLATTSBURGH ROJECT SCRIPTION SA PM SCOTT ST JOSEPH OJECT NUMBER REXUS (8NY2710)/ KAHUA (000015368) BMISSION STAGE 35% CD BMISSION DATE 09/26/2025 RAWN BY DDH DATE DRAWN: 09/26/25 HECKED BY DDH SHEET SIZE: 24 X 36 JOOR NUMBER SCIPLINE	2	SA PLATTSBURGH LLC 284 IDAHO AVENUE SBURGH, NY 12903-3988	OWNER IDEN
AND PROBLEM NO. SA PLATTSBURGH SOLDECT TITLE SOLDECT TIT	STUD	30 N GOULD STREET STE.N SHERIDAN, WY 82801	DESIGNER IDENTIFICATION
AND BALE PETERSON GUADAGNOLO CONSULTING ENGINEERS PROTECTION WISSA PLATTSBURGH PHISBONG PLATSBURGH 20001.1-Platisburgh GSA_R25.rvt OJECT TITLE GSA PLATTSBURGH 20001.1-Platisburgh GSA_R25.rvt OJECT TITLE GSA PLATTSB	_		STAMP OR SEAL
IME CONTR. NO. GS-02P-LNY00560 IME ORDER NO. IMEDIA ORDE			KEY PLAN
IME CONTR. NO. GS-02P-LNY00560 IME CONTR. NO.			GRAPHIC SCALE
PARTICIPA DE LIGHTING CALCULATION RESULT RENDERINGS PARTICIPA DE LIGHTING CALCULATIO	ark Date	Description	REVISION BLOCK
DILDING NAME WSSA PLATTSBURGH DIRESS 284 IDAHO AVENUE Plattsburgh, NY 12903-3988 M FILE NAME 230001.1-PlattsburghGSA_R25.rvt DIJECT TITLE GSA PLATTSBURGH ROJECT SCRIPTION RENOVATION OF EXISTING LEASED BUILDING WITH ADDITION SA PM SCOTT ST JOSEPH OJECT NUMBER REXUS (8NY2710)/ KAHUA (000015368) BMISSION STAGE 35% CD BMISSION DATE 09/26/2025 RAWN BY DDH DATE DRAWN: 09/26/25 HECKED BY DDH SHEET SIZE: 24 X 36 OOR NUMBER SCIPLINE HEET TITLE LIGHTING CALCULATION RESULT RENDERINGS SHEET NUMBER E-092	IME CONTR. NO. RIME ORDER NO. ONST. CONTR. NO. E ONST. CONTR. NO. ONST. CONTR.	STUDIO 40 SEVEN LLC	CONTRACTORS
ROJECT RENOVATION OF EXISTING LEASED BUILDING WITH ADDITION SA PM SCOTT ST JOSEPH OJECT NUMBER REXUS (8NY2710)/ KAHUA (000015368) IBMISSION STAGE 35% CD IBMISSION DATE 09/26/2025 RAWN BY DDH DATE DRAWN: 09/26/25 HECKED BY DDH SHEET SIZE: 24 X 36 OOR NUMBER SCIPLINE HEET TITLE LIGHTING CALCULATION RESULT RENDERINGS SHEET NUMBER E-092	JILDING NUMBER JILDING NAME DDRESS TY/ST./ZIP M FILE NAME	WSSA PLATTSBURGH 284 IDAHO AVENUE Plattsburgh, NY 12903-3988	BNILDING
HECKED BY DDH SHEET SIZE: 24 X 36 LOOR NUMBER SCIPLINE HEET TITLE LIGHTING CALCULATION RESULT RENDERINGS SHEET NUMBER E-092	COJECT TITLE ROJECT SCRIPTION SA PM COJECT NUMBER BMISSION STAGE BMISSION DATE	RENOVATION OF EXISTING LEASED BUILDING WITH ADDITION SCOTT ST JOSEPH REXUS (8NY2710)/ KAHUA (000015368) 35% CD	PROJECT IDENTIFICATION
		DDH SHEET SIZE: 24 X 36 LIGHTING CALCULATION RESULT RENDERINGS E-092	SHEET IDENTIFICATION


EXTERIOR LIGHTING FIXTURE SCHEDULE: GENERAL LIGHTING - SUBSTITUTIONS PERMITTED AS SHOWN


					AMERICA, BUY	BU	JG RATI	NG		LIGHT	SOURCE INFO	RMATION	I	LED DRIVE	२			
SYM.	STYLE	LIGHTING REP	MANUFACTURER	CATALOG NUMBER	AMERICA, BUY	BACK-	UP-		LAMP	TYPE	COLOR	COLOR	MIN.	CONTROL	MAX	MOUNTING	FINISH	NOTES:
		COMPANY			(BABA) COMPLIANT			GLARE	LED MODULE	OTHER	RENDERING INDEX (Ra)	TEMP.	DELIVERED LUMENS	VOLT. TYPE	WATTS			
Fy1 L	LL CUTOFF, BACKLIGHT	LIGHTSPEC MOXIE LIGHTING POINT SOURCE QUALITY LTG.	COOPER MCGRAW-EDISON	MODEL #BABA-GALN-SA2B-830-U-AFL-BZ-BCS-BPC-SPB2	✓	В0	UO	G1	✓	-	80+	3000K	5200 LM	120v PHOTOCELL, DIMMING OCC	85w	TAPERED ALUMINUM SQUARE	DARK BRONZE	
E x2 L	POST TOP AREA/SITE LUMINAIRE, IES TYPE 3 LEFT SIDE ONLY, FULL CUTOFF, HOUSE SIDE		COOPER MCGRAW-EDISON	MODEL #BABA-GALN-SA2B-830-U-SLL-BZ-HSS-BPC-SPB2	✓	B1	U0	G2	✓	-	80+	3000K	6500 LM	PHOTOCELL, DIMMING OCC SENSOR	82w	POLE, 20' TAPERED ALUMINUM SQUARE POLE, 20'	DARK BRONZE	
x3 R	POST TOP AREA/SITE UMINAIRE, IES TYPE 3 IGHT SIDE ONLY, FULL CUTOFF, HOUSE SIDE	VERTEX / ILLUM. LIGHTSPEC MOXIE LIGHTING POINT SOURCE QUALITY LTG. VERTEX / ILLUM.	COOPER MCGRAW-EDISON	MODEL #BABA-GALN-SA2B-830-U-SLR-BZ-HSS-BPC-SPB2	✓	B1	U0	G2	√	-	80+	3000K	6500 LM	120v PHOTOCELL, DIMMING OCC SENSOR	82w	TAPERED ALUMINUM SQUARE POLE, 20'	DARK BRONZE	
_	POST TOP AREA/SITE UMINAIRE, IES TYPE 4, FULL CUTOFF	LIGHTSPEC MOXIE LIGHTING POINT SOURCE	COOPER MCGRAW-EDISON	MODEL #BABA-GALN-SA1B-830-U-T4FT-BZ-BPC-SPB2	✓	B1	U0	G2	√	-	80+	3000K	4500 LM	120v PHOTOCELL, DIMMING OCC SENSOR	45w	TAPERED ALUMINUM SQUARE POLE, 20'	DARK BRONZE	
	JTOFF WALL PACK, IES TYPE 2	LIGHTSPEC MOXIE LIGHTING POINT SOURCE QUALITY LTG. VERTEX / ILLUM.		MODEL #BABA-GKO-PB1B-730-U-T2U-BZ-CBP-BPC-SPB2	✓	B1	U0	G1	√	-	70+	3000K	1350 LM	120v PHOTOCELL, DIMMING OCC SENSOR	11w	WALL	DARK BRONZE	PROVIDE WITH EMERGENCY BATTERY PACK, COLD WEAT RATED
	WALL MOUNT FULL JTOFF WALL PACK, IES TYPE 4	LIGHTSPEC MOXIE LIGHTING POINT SOURCE QUALITY LTG. VERTEX / ILL LIM	COOPER MCGRAW-EDISON	MODEL #BABA-GKO-PB1B-730-U-T4W-BZ-CBP-BPC-SPB2	✓	В0	U0	G1	✓	-	70+	3000K	1400 LM	120v PHOTOCELL, DIMMING OCC SENSOR	11w	WALL	DARK BRONZE	PROVIDE WITH EMERGENCY BATTERY PACK, COLD WEAT RATED


1 EXTERIOR LIGHTING FIXTURE SCHEDULE
E093 NOT TO SCALE

2	SA PLATTSBURGH LLC 284 IDAHO AVENUE SBURGH, NY 12903-3988	OWNER IDENTIFICATION
STUD	30 N GOULD STREET STE.N SHERIDAN, WY 82801 515.809.6020	DESIGNER IDENTIFICATION
	IOT FOR STRUCTION	STAMP OR SEAL
		KEY DI AN
		GRAPHIC SCALE
Mark Date	Description	BEVISION BLOCK
PRIME CONTR. NO. PRIME ORDER NO. CONST. CONTR. NO. A/E SUB A/E CONST. CONTR. BUILDING NUMBER BUILDING NAME	GS-02P-LNY00560 STUDIO 40 SEVEN LLC PETERSON GUADAGNOLO CONSULTING ENGINEERS NY7697ZZ WSSA PLATTSBURGH	CONTRACTORS
ADDRESS CITY/ST./ZIP BIM FILE NAME	284 IDAHO AVENUE Plattsburgh, NY 12903-3988 230001.1-PlattsburghGSA_R25.rvt	ENIO III IA
PROJECT TITLE PROJECT DESCRIPTION GSA PM PROJECT NUMBER SUBMISSION STAGE SUBMISSION DATE	GSA PLATTSBURGH RENOVATION OF EXISTING LEASED BUILDING WITH ADDITION SCOTT ST JOSEPH REXUS (8NY2710)/ KAHUA (000015368) 35% CD 09/26/2025	DRO IECT IDENTIFICATION
DRAWN BY CHECKED BY FLOOR NUMBER DISCIPLINE SHEET TITLE SHEET NUMBER	DDH DATE DRAWN: 09/26/25 DDH SHEET SIZE: 24 X 36 EXTERIOR LIGHTING FIXTURE SCHEDULE E-093 SHEET OF SHEETS	NOITY JIEITNEUL TEERS

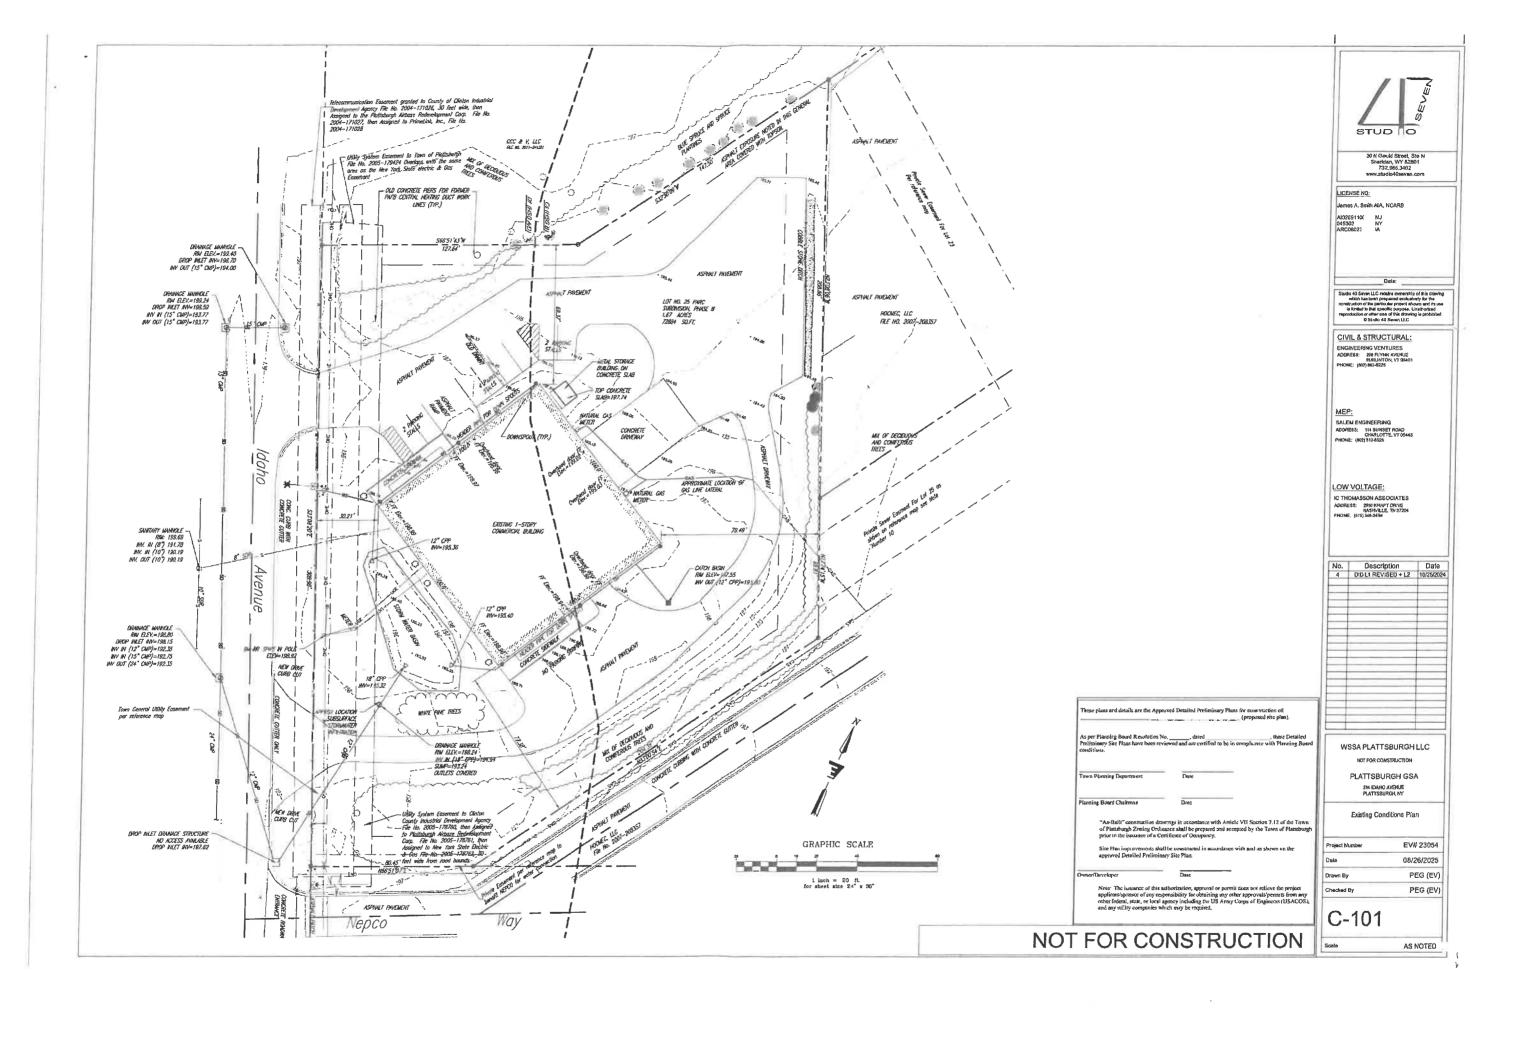

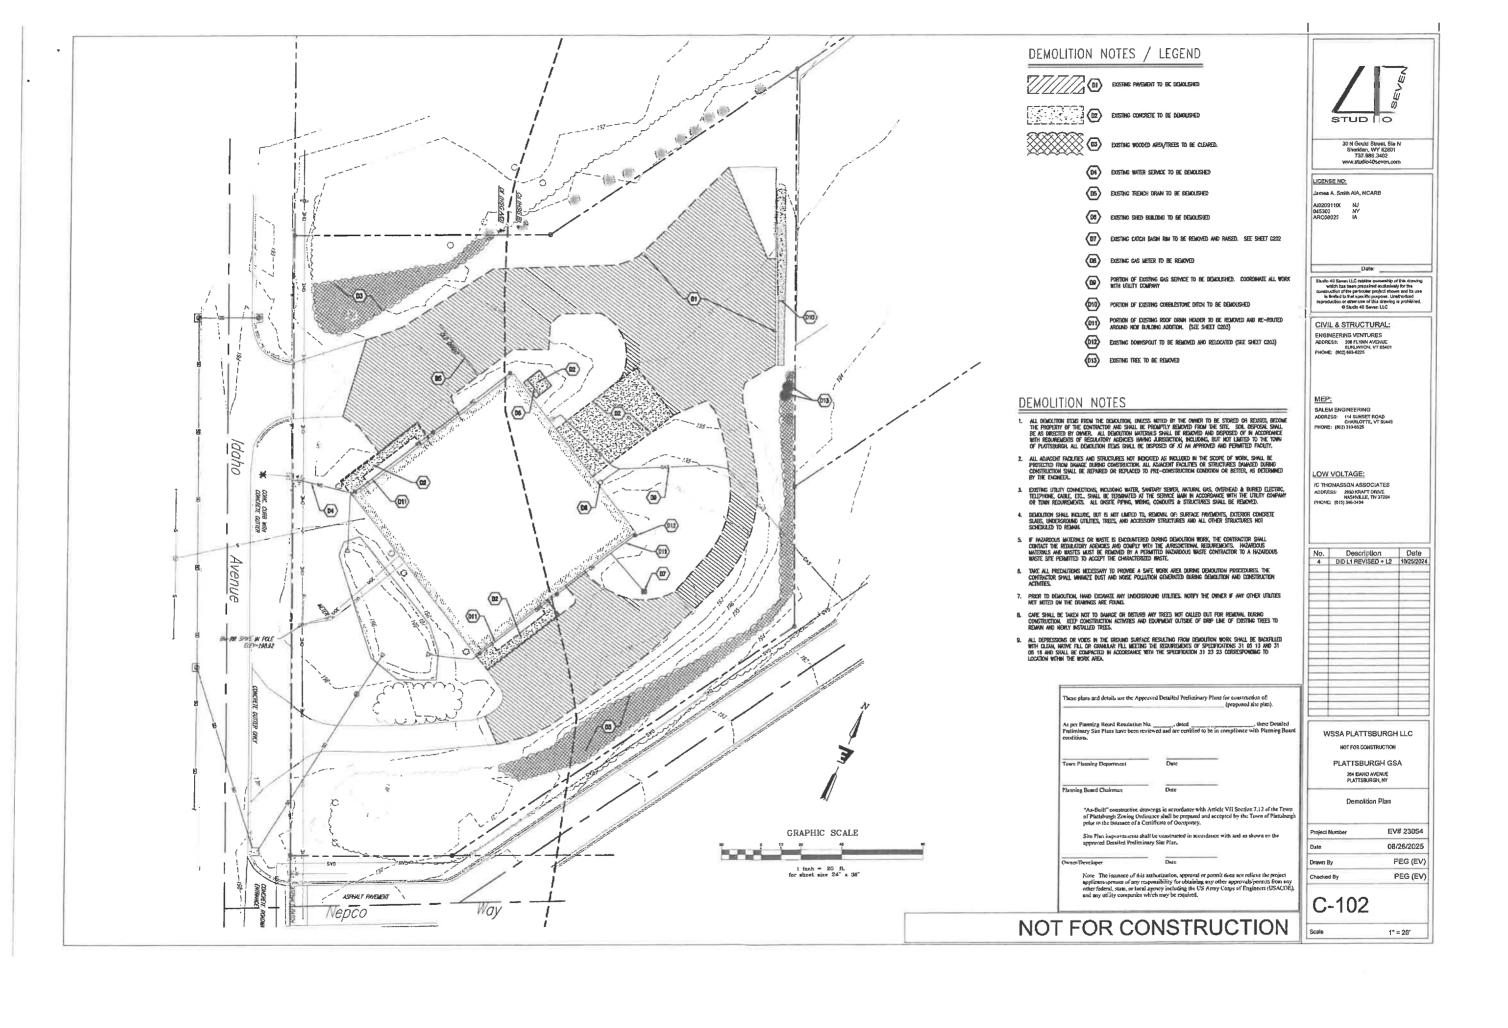

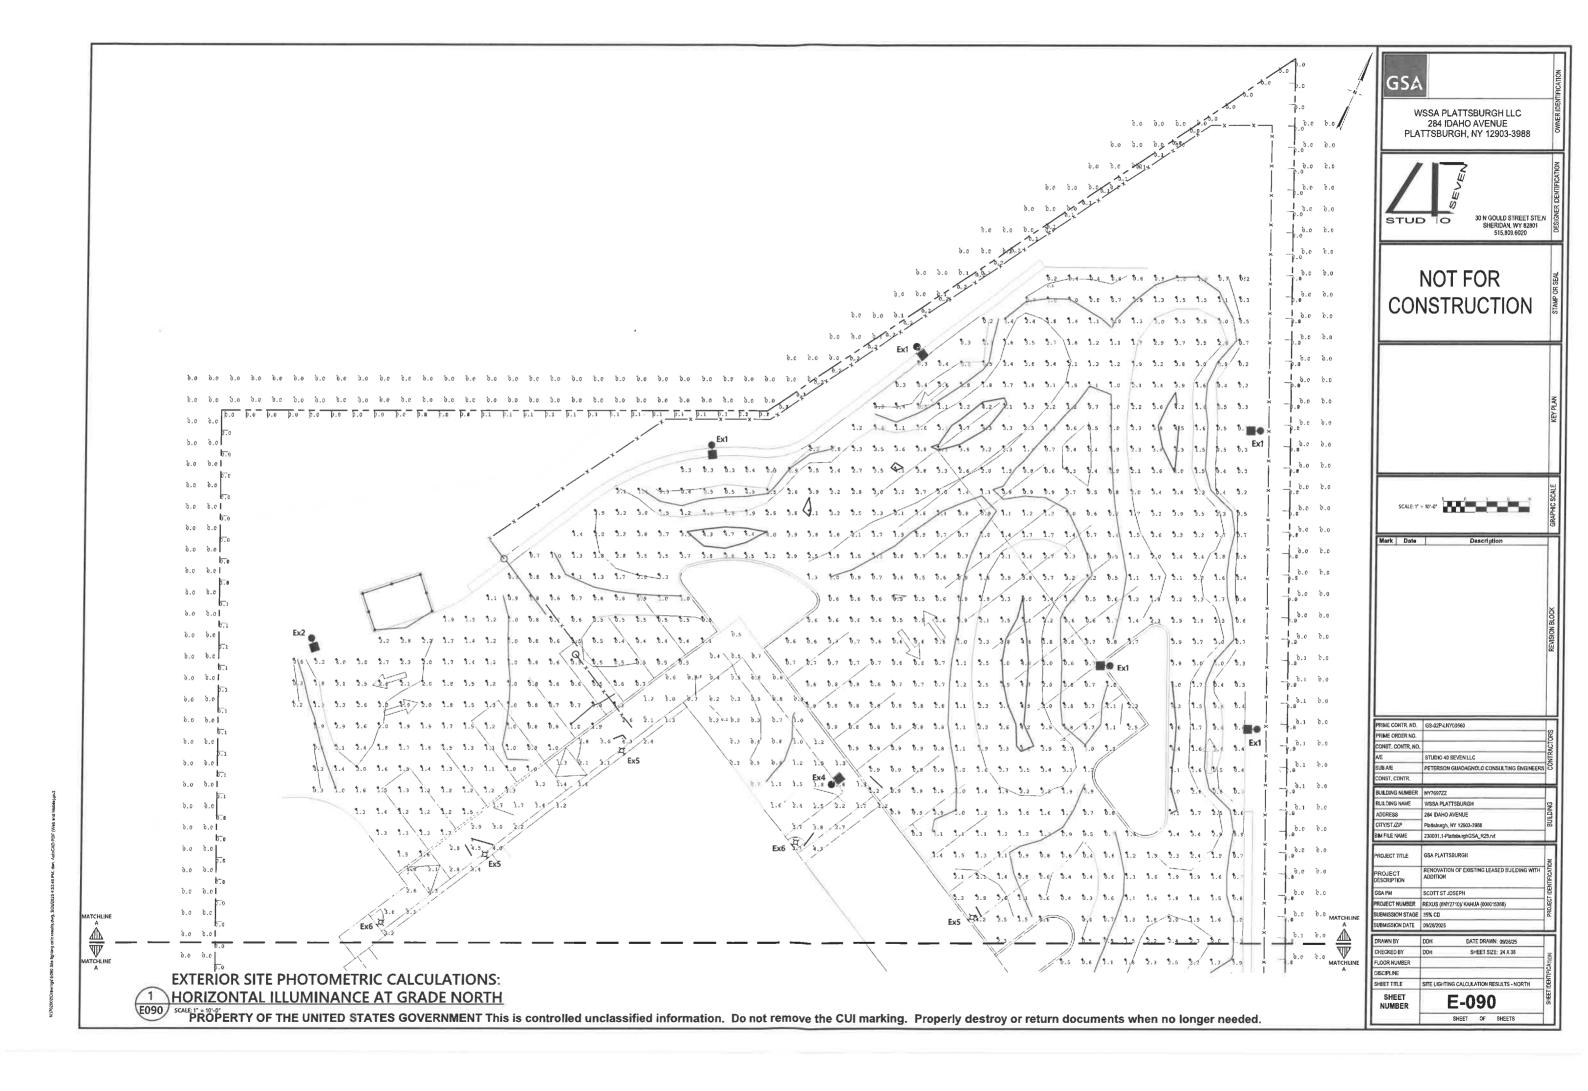

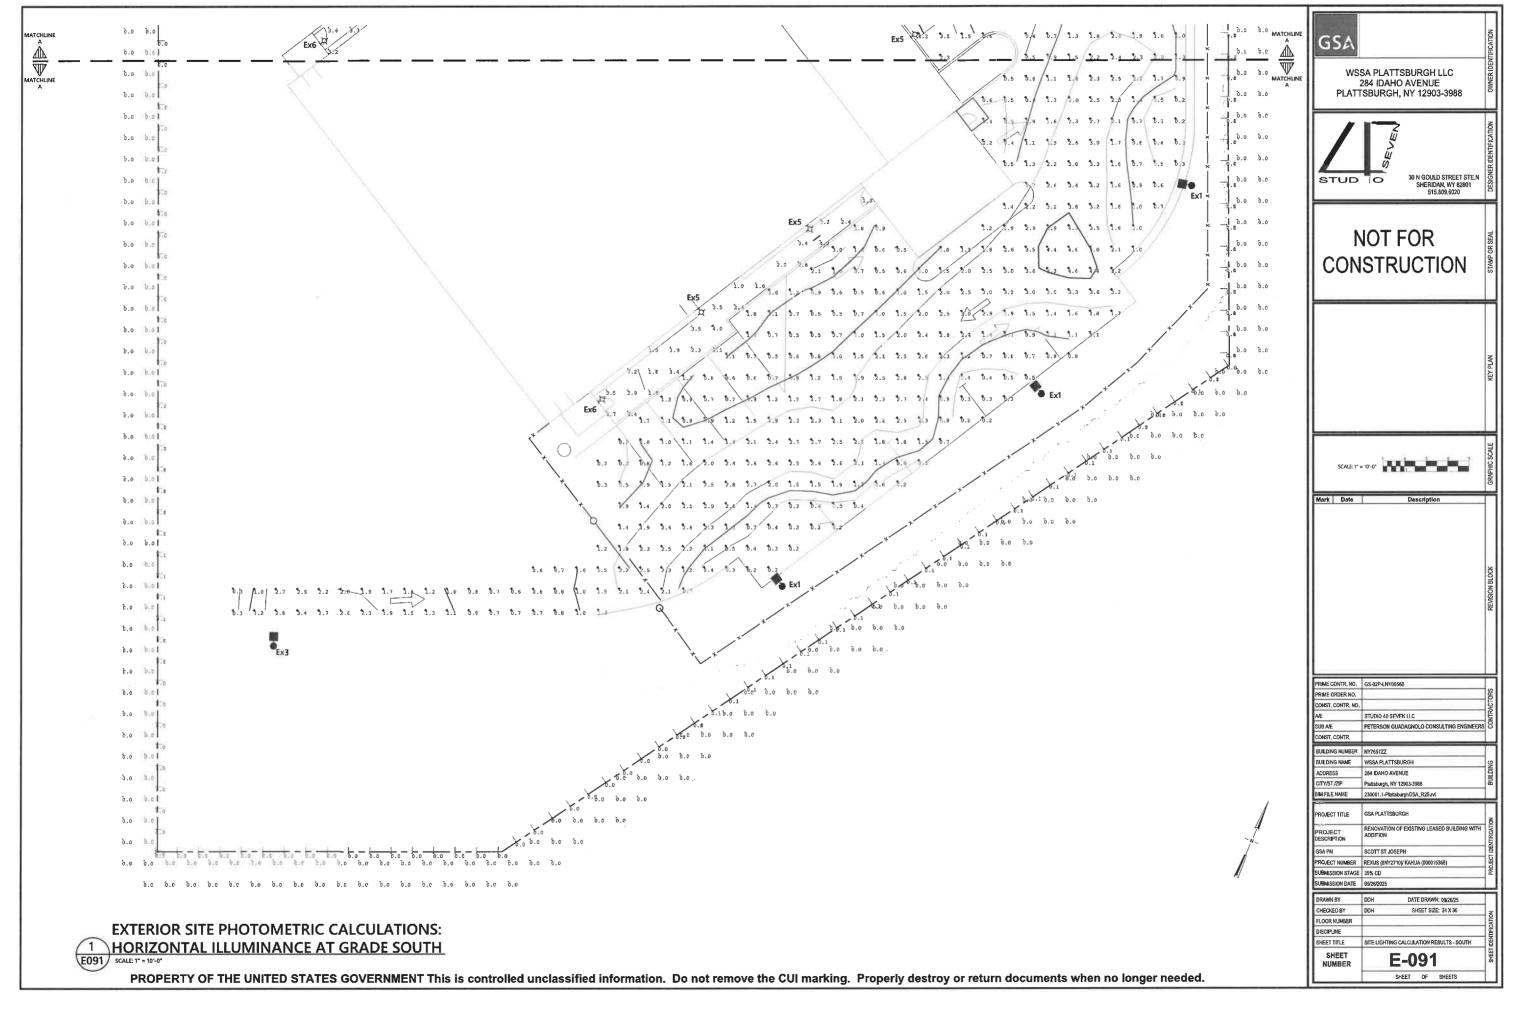

N:702002Drawings/E090 Site lighting calc results dwg, 9/26/2025 4;54;08 PM, dan. AutoCAD PDF (Yeb and Mobie);

